HAYSTACK

MIXED-USE DEVELOPMENT

SPAR RE-SUBMITTAL 2 - REV 2

MARCH 22, 2019







ARCHITE CTURE

PACIFICA

CONBULTANT

INGTON & COPELAND STREETS

SPAR SUBMIT 7.28.17
SPAR RESUBMIT 1 6.11.18
SPAR RESUBMIT 2 1.31.19
SPAR 2 - REV 1 2.26.19
SPAR 2 - REV 2 3.22.19

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TAMP

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SCALE

PROJECT NO. 1618 DRAWN BY IP

SHEET SIZE: 30 x 42

Glazed Conc Masonry REFR Refrigerator Above Finished Floor ACC GRN Reinforce (d), (ing) Acoustical Granite REM Addendum Gravel Remove RES Adhesive Resilient GWB Gypsum Wall Board RET ADJ Adjacent Return GYP Return Air Adjustable Air Conditionin Revision (s), Revised Alternate Riser HMTL Hollow Metal Roof Drain Aluminum RFH Anchor Bolt Roof Hatch RFG ANOD Annodized HDR Roofing Header HTG Heating APX Approximate Room RO ARCH Architect (ural) HVAC Heating/Ventilation/ Rubber Base Rubber Tile Height BSMT HC RWL Basement Hollow Core Rain Water Leader HOR BVL Beveled Horizontal Bituminous HB Hose Bib BLK Block HWH Hot Water Heater SAC Suspended Acoustical BLKG Blocking SASM Self Adhesive Sht INCL Include (d), (ing) Board Safety Glass B.O. Bottom Of SCD Inside Diameter See Civil (Eng) BRK Brick SCHD Schedule Insulate (d), (ing) BLDG Building Interior Screen SLNT INV BUR Built Up Roofing Sealant SEC Section CAB Cabinet SSK Service Sink CK SHTH Calk (ing) Caulk (ing) Joint Filler Sheathing Carpet (ed) Kickplate CSMT Casement Kitchen Square Feet CST CLG KO Cast Stone Knockout Sheet Glass Ceiling Similar CT SD Ceiling Height LBL Label See Landscape ER Ceramic Lag Bolt Solid Core LAM Laminate (d) CT SMD See Mechanical Ceramic Tile LAV LW CLR Clear (ance) Lavatory Soundproof Column Lightweight LWC Lightweight Concrete SPD CONC Concrete See Plumbing CMU Concrete Masonry Unit LMS Speaker Limestone CONST Construction Specification (s) CONT Continuous or Continue LPT Low Point SQ Square SS Control Joint Stainless Steel SSD Corner Guard See Structural STD Machine Bolt Standard Medium Density MDF STA Station Dampproofing Fiberboard Demolish, Demolition Manhole DTL STOR Detail Manufacture (r) Storage DIAG Masonry Storm Drain Diagonal DIA STR Diameter Masonry Opening Structural SUS Drain Maximum Suspended Dimension MECH Mechanic (al) SYM Symmetry (ical) Division Medicine Cabinet DH MET Double Hung Metal Sound Transmission MTFR Metal Furring Down Coefficient DS Downspout MWK Millwork MIN Minimum DWG Drawing Mirror Tempered TV Miscellaneous Television MLD Molding, Moulding THK Each Face Thick (ness) Electric (al) Threshold NR TPD Electrical Panelboard Toilet Paper Dispenser NOM Nominal Elevation Top of Plate ELEV Elevator Not In Contract TOS TST NTS Not to Scale EMER Emergency Top Of Slab EPDM Ethylene Propylene NO (#) Number Top Of Steel Diene Monomer EQ EQP Top Of Wall Equal TB Equipment EST Tread Estimate EXH Exhaust OBS TYP Obscure Typical EB OC Expansion Bolt On Center (s) EJ OFS Over Flow Drain UNF Expansion Joint Unless Otherwise Noted EXP OFS Overflow Scupper UON Exposed Opaque ÈΧΤ OPG Exterior Opening Vaulted Opposite Fiberglass Clad VAR Outside Diameter VB Face Of Concrete Overall Vapor Barrier Face Of Finish Overhead VNR Veneer **VERT** Face Of Masonry Vertical Face Of Studs Paper Towel Receptor VG Vertical Grain Finish Floor Particle Board Finish (ed) Vinyl Acoustical Tile Finished Floor Elevation PTN Partition Vinvl Base Vinyl Composite Tile VCT Fire Alarm Particle Board Fireproof PERF Perforate (d) W/ PERI Perimeter With Fire-resistant PLAM Plastic Laminate WSCT Wainscot Fire-retardant Floor Plate Glass Wall To Wall

PWD Plywood

Point

PVC Polyvinyl Chloride

PCC Precast Concrete

Prefinished

Preformed

RWL Rainwater Leader

REC Recessed

REF Reference

Property Line

Pressure Treated

PFB Prefabricate (d)

Pounds Per Square

Pounds Per Square Inch WR Precast Concrete WRB

WH

WP

WM

WB

WI

Wall Hung

Water Closet

Water Proof

Waterstop

Wired Glass

Wire Mesh

Wood Base

Without

Wood

WDW Window

ABBREVIATIONS

Weather Resistant

Welded Wire Fabric

FLR Floor (ing) FLS Flashing

FD Floor Drain

FLUR Fluorescent

FJT Flush Joint

FND Foundation

FRM Frame (ing)

FUR Furred (ing)

GΑ

GV

GC

Grade

GLB Glass Block

Gage, Gauge Galvanized

Glass, Glazing

General Contractor

FTG Footing

GSM Galvanized Sheet Metal RFL

APPLICABLE BUILDING CODES:

2016 CALIFORNIA BLUILDING CODE & AMENDMENTS 2016 CALIFORNIA MECHANICAL CODE & AMENDMENTS 2016 CALIFORNIA PLUMBING CODE & AMENDMENTS 2016 CALIFORNIA ELECTRICAL CODE & AMENDMENTS 2016 CALIFORNIA ENERGY CODE 2016 CALIFORNIA FIRE CODE & AMENDMENTS 2016 CALIFORNIA BLUILDING CODE CHAPTER 11A 2016 CALIFORNIA BLUILDING CODE CHAPTER 11B

PROJECT DESCRIPTION:

PETALIMA SMART CODE

DEMOLITION OF EXISTING STRUCTURE ON SITE. ON AND OFF-SITE UPGRADES OF UNDERGROUND UTILITIES AND SIDEWALK; INCLUDING STORM DRAIN.

NEW CONSTRUCTION OF MARKET RATE, (3-4) STORY, CONSTRUCTION TYPE VA CONSISTING OF MIXED-USE AROUND (2) STORY TYPE IA OR IIA GARAGE WITH OPEN-AIR COURTYARD ABOVE. SITE IS SUBJECT TO PETALUMA SMART CODE. PROJECT WILL HAVE A MIX OF GROUND FLOOR USES INCLUDING: LIVE/WORK UNITS, COMMERCIAL, LEASING OFFICE AND RESIDENTIAL AMENITIES. FLOORS 2-4 WILL BE RESIDENTIAL DWELLING UNITS; 178 TOTAL

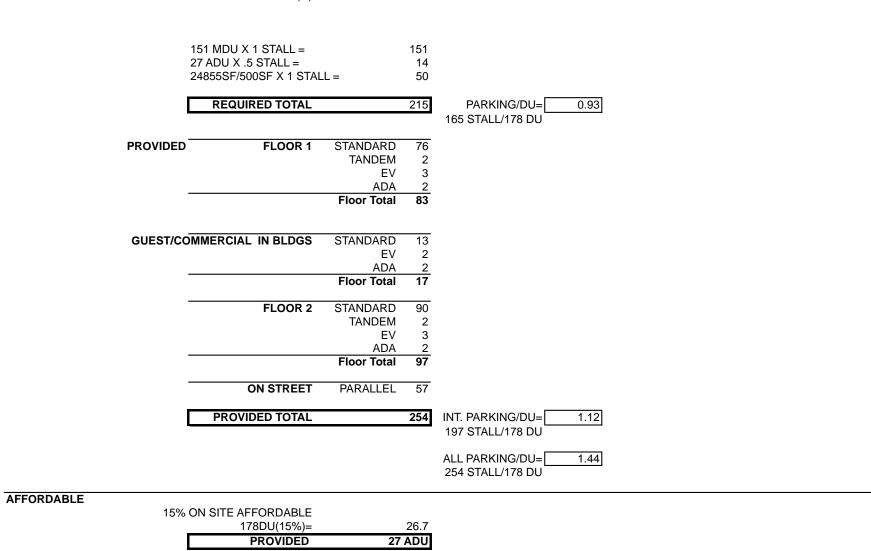
DWELLING UNITS (27 DWELLING UNITS WILL BE BELOW MARKET RATE). PROJECT EXCEEDS MINIMUM PARKING REQUIREMENTS. COMMERCIAL/GUEST PARKING WILL BE LOCATED IN GARAGE AND ON STREET. RESIDENTIAL PARKING WILL BE 100% ASSIGNED PARKING AND ACCESS CONTROLLED (FLOORS 1 AND 2).

PROJECT INFORMATION

HAYSTACK, PETALUMA UNIT AND AREA SUMMARY: Unit Measured Centerline Corridor, Demising and Exterior

CONSTRUCTION	I TYPE:		VA AROUND IA	١						
FLOORS:			4 WOOD AROL	JND 2 CONCRET	E					
			Unit Rentable*	Floor Levels					Unit	Rentable Area
UNIT TYPE			SF	1ST	2ND	3RD	4TH	Total	1	by Type
STUDIO	S1	STUDIO	574	0	7	7	2	16		9,184
								16	9.0%	
1 BEDROOM	A1.0	1 BED/ 1BATH	725	3	7	7	6	23		16,675
İ								0		0
I	A2.0	1 BED/1 BATH	872	4	4	4	4	16		13,952
1								0		0
	A3.0	1 BED/1 BATH	784	4	4	4	4	16		12,544
								0		0
LIVE/WORK	F1	LIVE/WORK	1,724	1	0	0	0	1		1,724
	F2	LIVE/WORK	1,149	1	0	0	0	1		1,149
	F3	LIVE/WORK	1,057	1	0	0	0	1		1,057
								58	32.6%	
2 BEDROOM	B1.0	2 BED/2 BATH	1,057	7	18	18	18	61		64,477
								0		0
	B2.0	2 BED/2 BATH	1,168	3	11	11	8	33		38,544
								0		0
								94	52.8%	
3 BEDROOM	C1.0	3 BED/2BATH	1,338	1	3	3	3	10		13,380
								0		0
								10	5.6%	0
-										172,686
TOTAL UNITS	•	•	970	25	54	54	45	178	100%	
Rentable Reside	ntial by floor	(not incl. decks)		24,970	51,605	51,605	44,506			172,686
	•	,			1 01,000	1 01,000	1 1,000			,,,,,,,
Gross Residentia	al (lobby, corridors	s, stairs, etc) (incl. decks)		15,691	19,189	18,218	18,218			71,316
Amenity Spaces (Interior Only)			2,467	3,475	1,695	1,695			9,332	
Leasing (inc. in Amenity)			4,714						4,714	
Commercial			24,855						24,855	
Garage (Incl. storage, utilities,)			39,234	39,479					78,713	

VEHICLE PARKING MARKET RATE (M) 1 DU X 1 STALL AFFORDABLE (A) 1 DU X 0.5 STALL COMMERCIAL (C) 500SF X 1 STALL



111,931 113,748 71,518 64,419

361,616

STATISTICS +

SITE VICINITY MAP

PACIFICA HAYSTACK LP 1775 HANCOCK ST., ST 200 SAN DIEGO, CA 92110 P: (619) 296 -9000 X185 CONTÁCT: ABBIE HAWKINS

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PROJECT TEAM

PROJECT INFORMATION

PROJECT INFORMATION **EXISTING CONDITIONS** REGULATING PLAN, ZONES T5 &T6 BUILDING FUNCTION DIAGRAMS BUILDING PLACEMENT & CIVIC REQUIREMENTS A0.05 BUILDING BLOCK DIAGRAM

CIVIL C-1

TITLE SHEET C-2 CONTEXT PLAN C-3 **EXISTING CONDITIONS EXHIBIT** TENTATIVE PARCEL MAP PROJECT STREET EXHIBIT

STREET SECTION - WELLER STREET & E. WASHINGTON STREET STREET SECTIONS - COPELAND AND TRANSVERSE STREETS STREET SECTIONS - "D" STREET OFF-SITE CIRCULATION PLAN

C-9 C-10 ON-SITE ADA COMPLIANT ROUTING AND CIRCULATION PLAN C-11 PRELIMINARY GRADING PLAN - NORTH C-12 PRELIMINARY GRADING PLAN - SOUTH

C-13 PRELIMINARY UTILITY PLAN C-14 SIGNING AND STRIPING C-15 EXISTING PUBLIC ON-STREET PARKING EXHIBIT C-16 PROJECT PROPOSED PARKING PLAN

C-17 WELLER STREET PARKING EXHIBIT C-18 PFD LADDER TRUCK STAGING EXHIBIT PFD LADDER TRUCK CIRCULATION EXHIBIT STORMWATER MITIGATION PLAN LID-1

STREETSCAPE PLAN ROOFTOP LANDSCAPE PLAN STREETSCAPE & ROOFTOP RENDERING L-1.4 PLANT LIST L-1.5 GROUND FLOOR STORMWATER MANAGEMENT

LANDSCAPE

ARCHITECTURAL BUILDING SITE PLAN, BUILDING FLOOR PLANS 01 & 02

BUILDING FLOOR PLANS 03 & 04 ROOF PLAN & ELEVATOR/STAIR PLANS **BUILDING A - BUILIDNG PLAN FLOOR 1 BUILDING B - BUILIDNG PLAN FLOOR 1 BUILDING A - BUILIDNG PLAN FLOOR 2** BUILDING B - BUILIDNG PLAN FLOOR 2 **BUILDING A - BUILIDNG PLAN FLOOR 3** BUILDING B - BUILIDNG PLAN FLOOR 3 BUILDING A - BUILIDNG PLAN FLOOR 4 A2.3B BUILDING B - BUILIDNG PLAN FLOOR 4 A2.4A BUILDING A - BUILIDNG PLAN ROOF A2.4B BUILDING B - BUILIDNG PLAN ROOF

EXTERIOR ELEVATIONS A3.0 A3.1 EXTERIOR ELEVATIONS **BLDG SECTIONS** A3.2 TYPICAL UNIT PLANS

RENDERING & PRECEDENCE A5.1 RENDERING & PRECEDENCE RENDERING & PRECEDENCE A5.3 MATERIALS A5.4 MATERIALS

EXTERIOR DETAILS

SHEET INDEX

950 HOWARD STREET SAN FRANCISCO CA 94103 P. (415)677-0966

ARCHITECTURE

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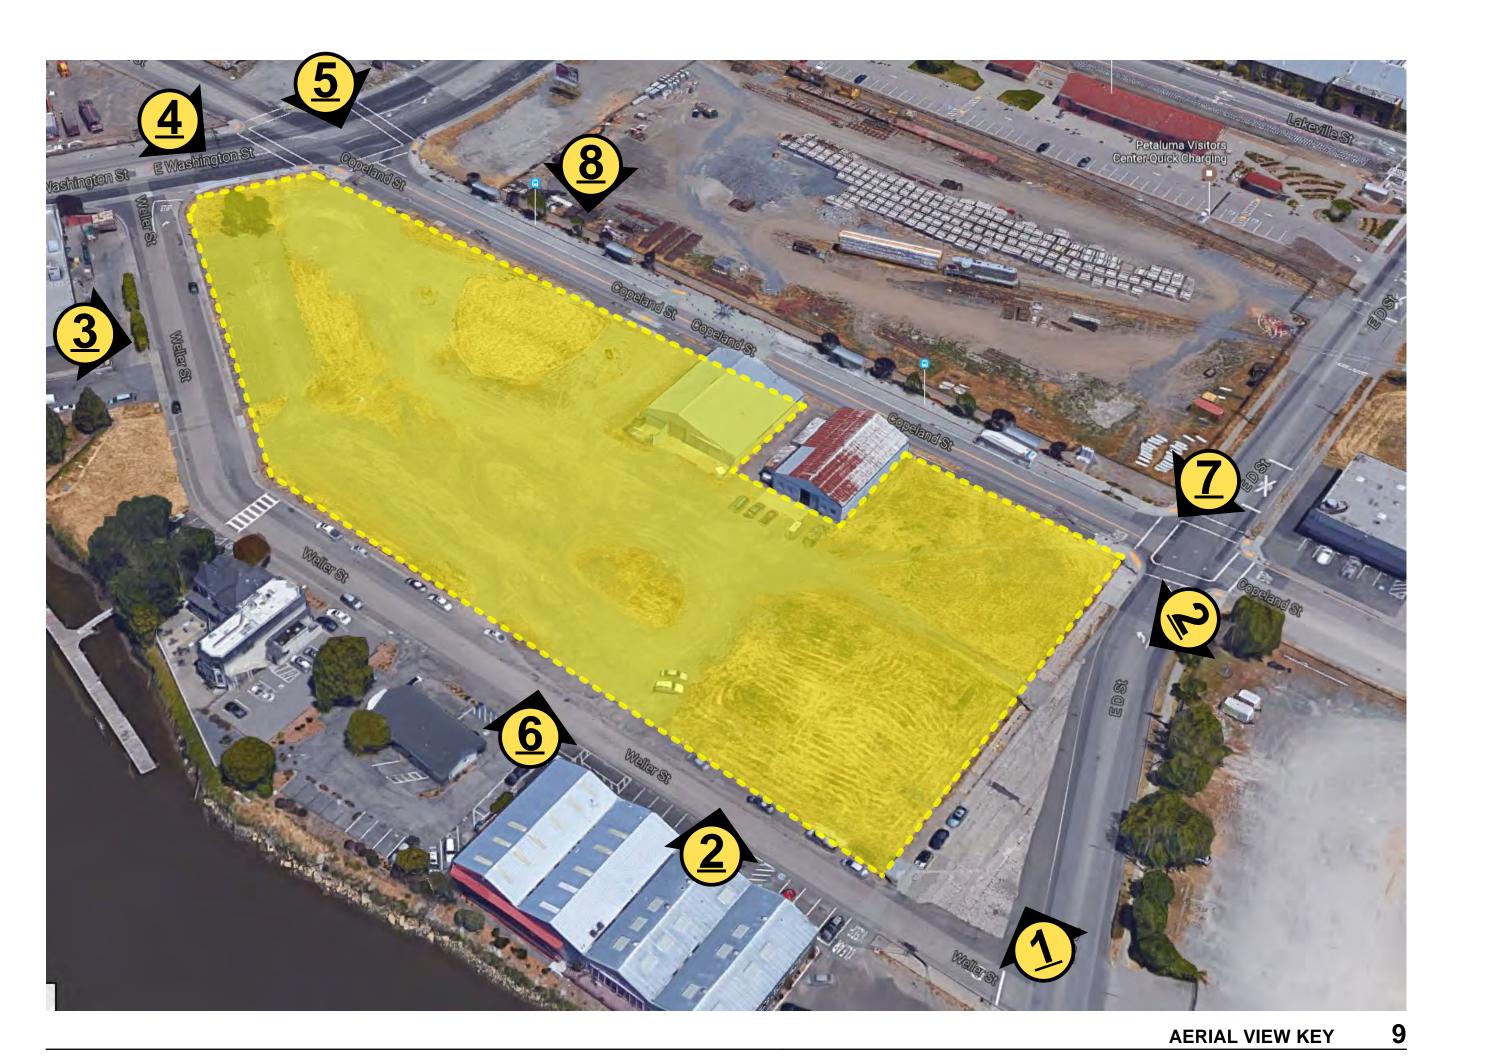
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PROJECT NO. 1618 DRAWN BY IP

SHEET SIZE: 30 x 42









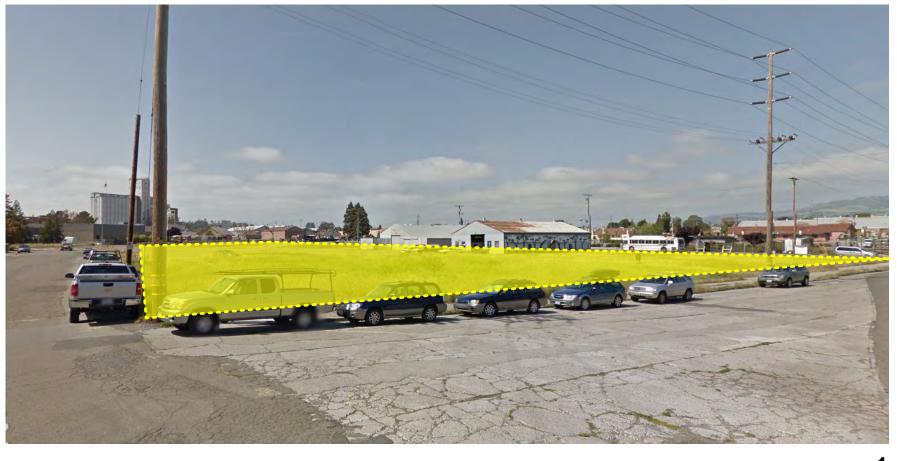




D & COPELAND STREET 7 WELLER ST NEAR WASHINGTON







WASHINGTON ST 5

ISSUE	DATE

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EXISTING CONDITIONS

SCALE

PROJECT NO. DRAWN BY XX

SHEET SIZE: 30 x 42

ZONE T5 - URBAN CENTER

- HIGHER DENSITY MIXED-USE BUILDINGS
- RETAIL, OFFICES, ROWHOUSES, APARTMENTS • TIGHT NETWORK OF STREETS, WIDE SIDEWALKS, STREET TREE PLATING
- BUILDINGS ARE SET CLOSE TO SIDEWALK
- **FRONTAGE TYPES:** • STOOPS, SHOPFRONTS, GALLERIES
- **CIVIC SPACES**: PARKS, PLAZAS, SQUARES

ZONE T6 - URBAN CORE

- HIGHEST DENSITY AND HEIGHT
- CIVIC BUILDINGS, MIXED USE, ENTERTAINMENT, CULTURAL USES
- LARGER BLOCKS
- STREET TREE PLANTING
- BUILDINGS ARE SET CLOSE TO SIDEWALK
- SHALLOW SETBACKS
- **FRONTAGE TYPES:**
- STOOPS, DOORYARDS, FORECOURTS, SHOPFRONTS, GALERIES, ARCADES **CIVIC SPACES**:
- PARKS, PLAZAS, SQUARES

SECTION 2 2.20 - REGULATING PLAN DOWNTOWN STATION AREA

URBAN CORE (T6) URBAN CORE - OPEN (T6-O) URBAN CENTER (T5)

CORNER ELEMENT REQUIRED

URBAN CORE - OPEN (T6-O)
—ALLOWS ADDITIONAL GROUND FLOOR USES (See Diagram1/A0.03)



ARCHITECTURE

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COMPANIES Shaping real estate globally... since 1978

REGULATING PLAN ZONES T5 & T6

PROJECT NO. 1618 DRAWN BY IP

SECTION 4 URBAN STANDARDS

REQUIRED 4.40.150: FRONTAGE TYPE REGULATING PLAN DOWNTOWN STATION AREA SHOPFRONT, TERRACE, OR GALLERY REQUIRED

GALLERY REQUIRED SHOPFRONT, TERRACE, GALLERY, OR DOORYARD WITH SHOPFRONT REQUIRED STOOP OR DOORYARD REQUIRED OPEN FRONTAGE (ANY FRONTAGE TYPE ALLOWED PER APPLICABLE TRANSECT

4.40.030: FRONTAGE TYPE OVERVIEW STOOP: T5

ZONES: T5 &T6)

- MAIN FACADE IS NEAR THE FRONTAGE LINE
- ELEVATED STOOP ENGAGES THE SIDEWALK
- STOOP S TO BE ELEVATED ABOVE SIDEWALK
- STAIRS LEAD DIRECTLY TO THE SIDEWALK/ OR SIDE-LOADED

FORECOURT: T5

- MAIN FACADE IS AT OR NEAR FRONTAGE LINE
- SMALL PERCENTAGE OF MAIN FACADE IS SET BACK CREATING THE FORECOURT • CAN BE USED AS ENTRY COURT, GARDEN, OR ADDITIONAL SHOPPING/RESTAURANT
- SEATING AREA

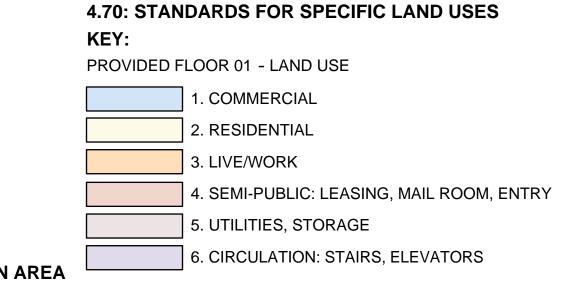
SHOPFRONT: T5

- MAIN FACADE IS AT OR NEAR THE FRONTAGE LINE WITH AT-GRADE ACCESS WHILE ACCOMMODATING AT-GRADE CHANGE
- FREQUENT STEPS UP TO THE TERRAE ARE NECESSARY TO AVOID DEAD WALLS AND MAXIMIZE ACCESS

GALLERY: T5 & T6

- MAIN FACADE IS AT THE FRONTAGE LINE, GALLERY ELEMENT OVERLAPS THE SIDEWALK
- INTENDED FOR BUILDING WITH GROUND FLOOR COMMERCIAL USES
- CAN BE ONE OR TWO-STORIES
- PROVIDES PRIMARY CIRCULATION ALONG FRONTAGE
- EXTENDS FAR FROM BUILDING TO PROVIDE ADEQUATE PROTECTION AND CIRCULATION

FOR PEDESTRIANS



4.70.020: LIVE/WORK UNITS

D. NET TOTAL FLOOR AREA OF LIVE/WORK SHALL NOT EXCEED 3,000 SF

—SEPARATION AND ACCESS

—ACCESS TO EACH LIVE/WORK UNIT SHALL BE PROVIDED FROM SHOP FRONTS

4.70.030: MIXED-USE PROJECT


- A. SHALL PROVIDE
- —BLEND OF COMMERCIAL SPACE AND RESIDENTIAL UNITS
- —CONCENTRATE ON HIGH DENSITY RESIDENTIAL DOWELING AND COMMERCIAL OPERATIONS
- —PROVIDE DIVERSE RANGE OF HOUSING TYPES —PROMOTE CONTINUED ACTIVITY

4.70.040: BUILDING MATERIAL GUIDELINES

A. BUILDING MATERIALS

- —NATURAL MATERIALS THAT AGE GRACEFULLY
- ---MATERIALS SUCH AS CENTERBOARD/SIDING ARE ALLOWED IF CAN SIMULATE NATURAL MATERIAL AND HAS WEATHERING CHARACTERISTICS

MATERIAL AND	HAS WEATH	ERING CHARA	CIERISTICS

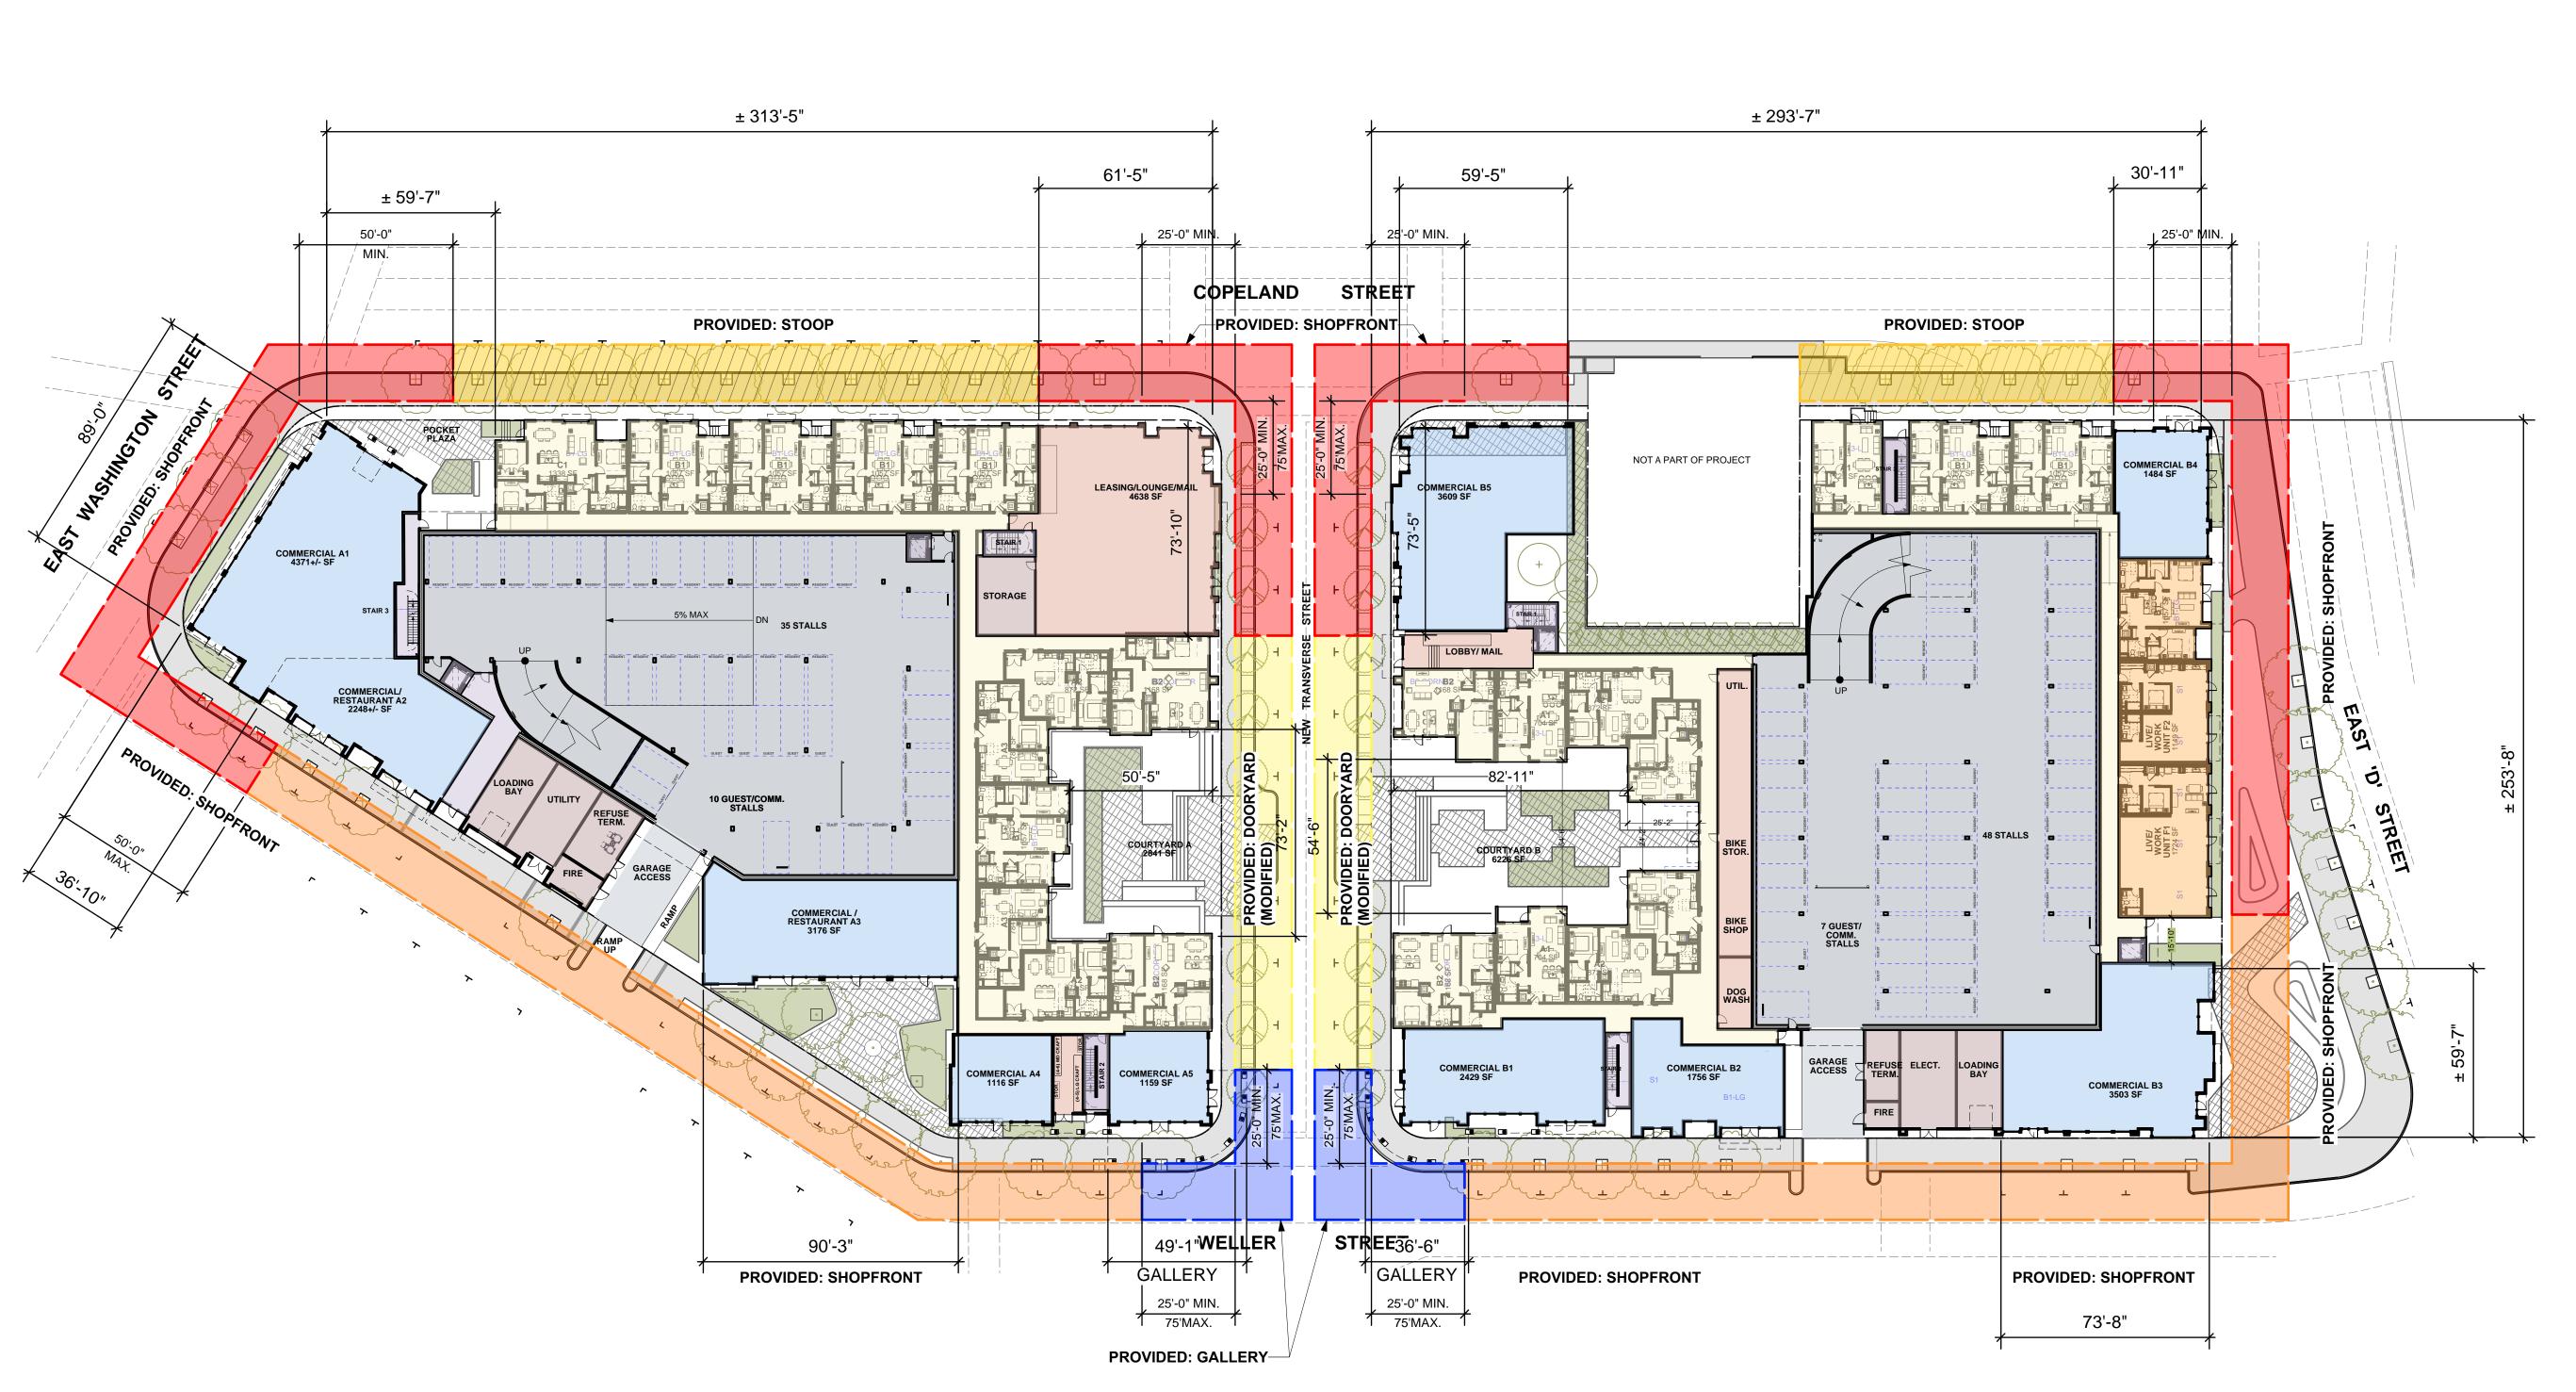

CUP CUP P P CUP CU	P2 CUP P2 P2 CUP P2 CUP P2 P2 CUP P2 P2 CUP P2 P2 CUP P2 P1 CUP P2 P1 P2 MUP P1 CUP P1 P1 CUP P1	MUP² CUP² P² P² P² MUP P² CUP² P² MUP P² CUP² P² CUP² P² CUP² P² CUP² P² CUP² P P CUP	MUP CUP P P P P P P P P P CUP P P MUP P CUP P MUP P CUP P MUP P P MUP				CUP CUP P CUP CUP CUP P CUP P CUP P CUP P CUP P P CUP P P CUP P P CUP P P P
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							P
							CUP
_	CUP	_	_	CUP	_	_	Р
CUP	MUP ²	MUP ²	MUP ²	Р	_	_	P
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_	_			CUP			CUP
CUP –	P CUP ²	P^2 MUP^2	P MUP	P CUP	_ _	_	P CUP
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P ³	MUP ^{2,3}			_	=	Р	-
CUP	MUP ^{2,3}	CUP ^{2,4}	CUP ^{2,4}	P	-	Р	_
	-			CUP	-	Р	_
CUP ³	CUP ² ,3			CUP	-	P P	_
CUP ³	CUP ^{2,3} P ²		-	- Р	-	P P	
-		-	-	CUP	_	CUP	-
-	_			CUP -	-	CUP P	-
P ²	P ²	P ² CUP ^{2,4}	P ² CUP ^{2,4}	P ²	-	P	P _
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ARCHITECTURE

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BUILDING

DIAGRAMS

SHEET SIZE: 30 x 42

BUILDING THAT OCCUPIES BOUNDARIES OF ITS LOT

INTERNALLY DEFINED ONE OR MORE PRIVATE PATIOS

SHIELDS PRIVATE FROM PUBLIC

RECOMMENDED FOR WORKSHOPS

HIGH SECURITY PROVIDED BY CONTINUOUS ENCLOSURE

4.80.030: BUILDING TYPES

COURTYARD BUILDING: T5

MEDIUM TO LARGE SIZED STRUCTURE

MULTIPLE SIDE-BY-SIDE /STACKED DWELLING UNITS

 ACCESSED FROM A COURTYARD(S) OWN ENTRY OR SHARED ENTRY

MAIN STREET BUILDING: T5 &T6

SMALL TO MEDIUM SIZED STRUCTURE

INTENDS TO PROVIDE VERTICAL MIX OF USES

 GROUND FLOOR - COMMERCIAL, SERVICES • UPPER FLOORS - RESIDENTIAL

INCLUDES LIVE/WORK UNITS

PRIMARY COMPONENT OF A NEIGHBORHOOD MAIN STREET

KEY COMPONENT TO WALKABILITY

4.50.030: CIVIC SPACE TYPES AND REQUIREMENTS

POCKET PLAZA

• FORMAL OPEN SPACE AVAILABLE FOR CIVIC PURPOSES AND COMMERCIAL ACTIVITIES

 TYPICALLY HARDSCAPED FORMAL CHARACTER

• 2,000 SF TO 1/2 ACRE

POCKET PARK

• OPEN SPACE AVAILABLE FOR INFORMAL ACTIVITIES IN CLOSE PROXIMITY

TO NEIGHBORHOOD RESIDENCES

2,000 SF TO 1 ACRE

DOORYARD

•SMALL OUTDOOR FRONTAGE FOR GROUND FLOOR RESIDENTIAL, LIVE/WORK AND COMMERCIAL ACTIVITIES

•DEPTH: 8' MIN.

•LENGHT: 50' MAX.

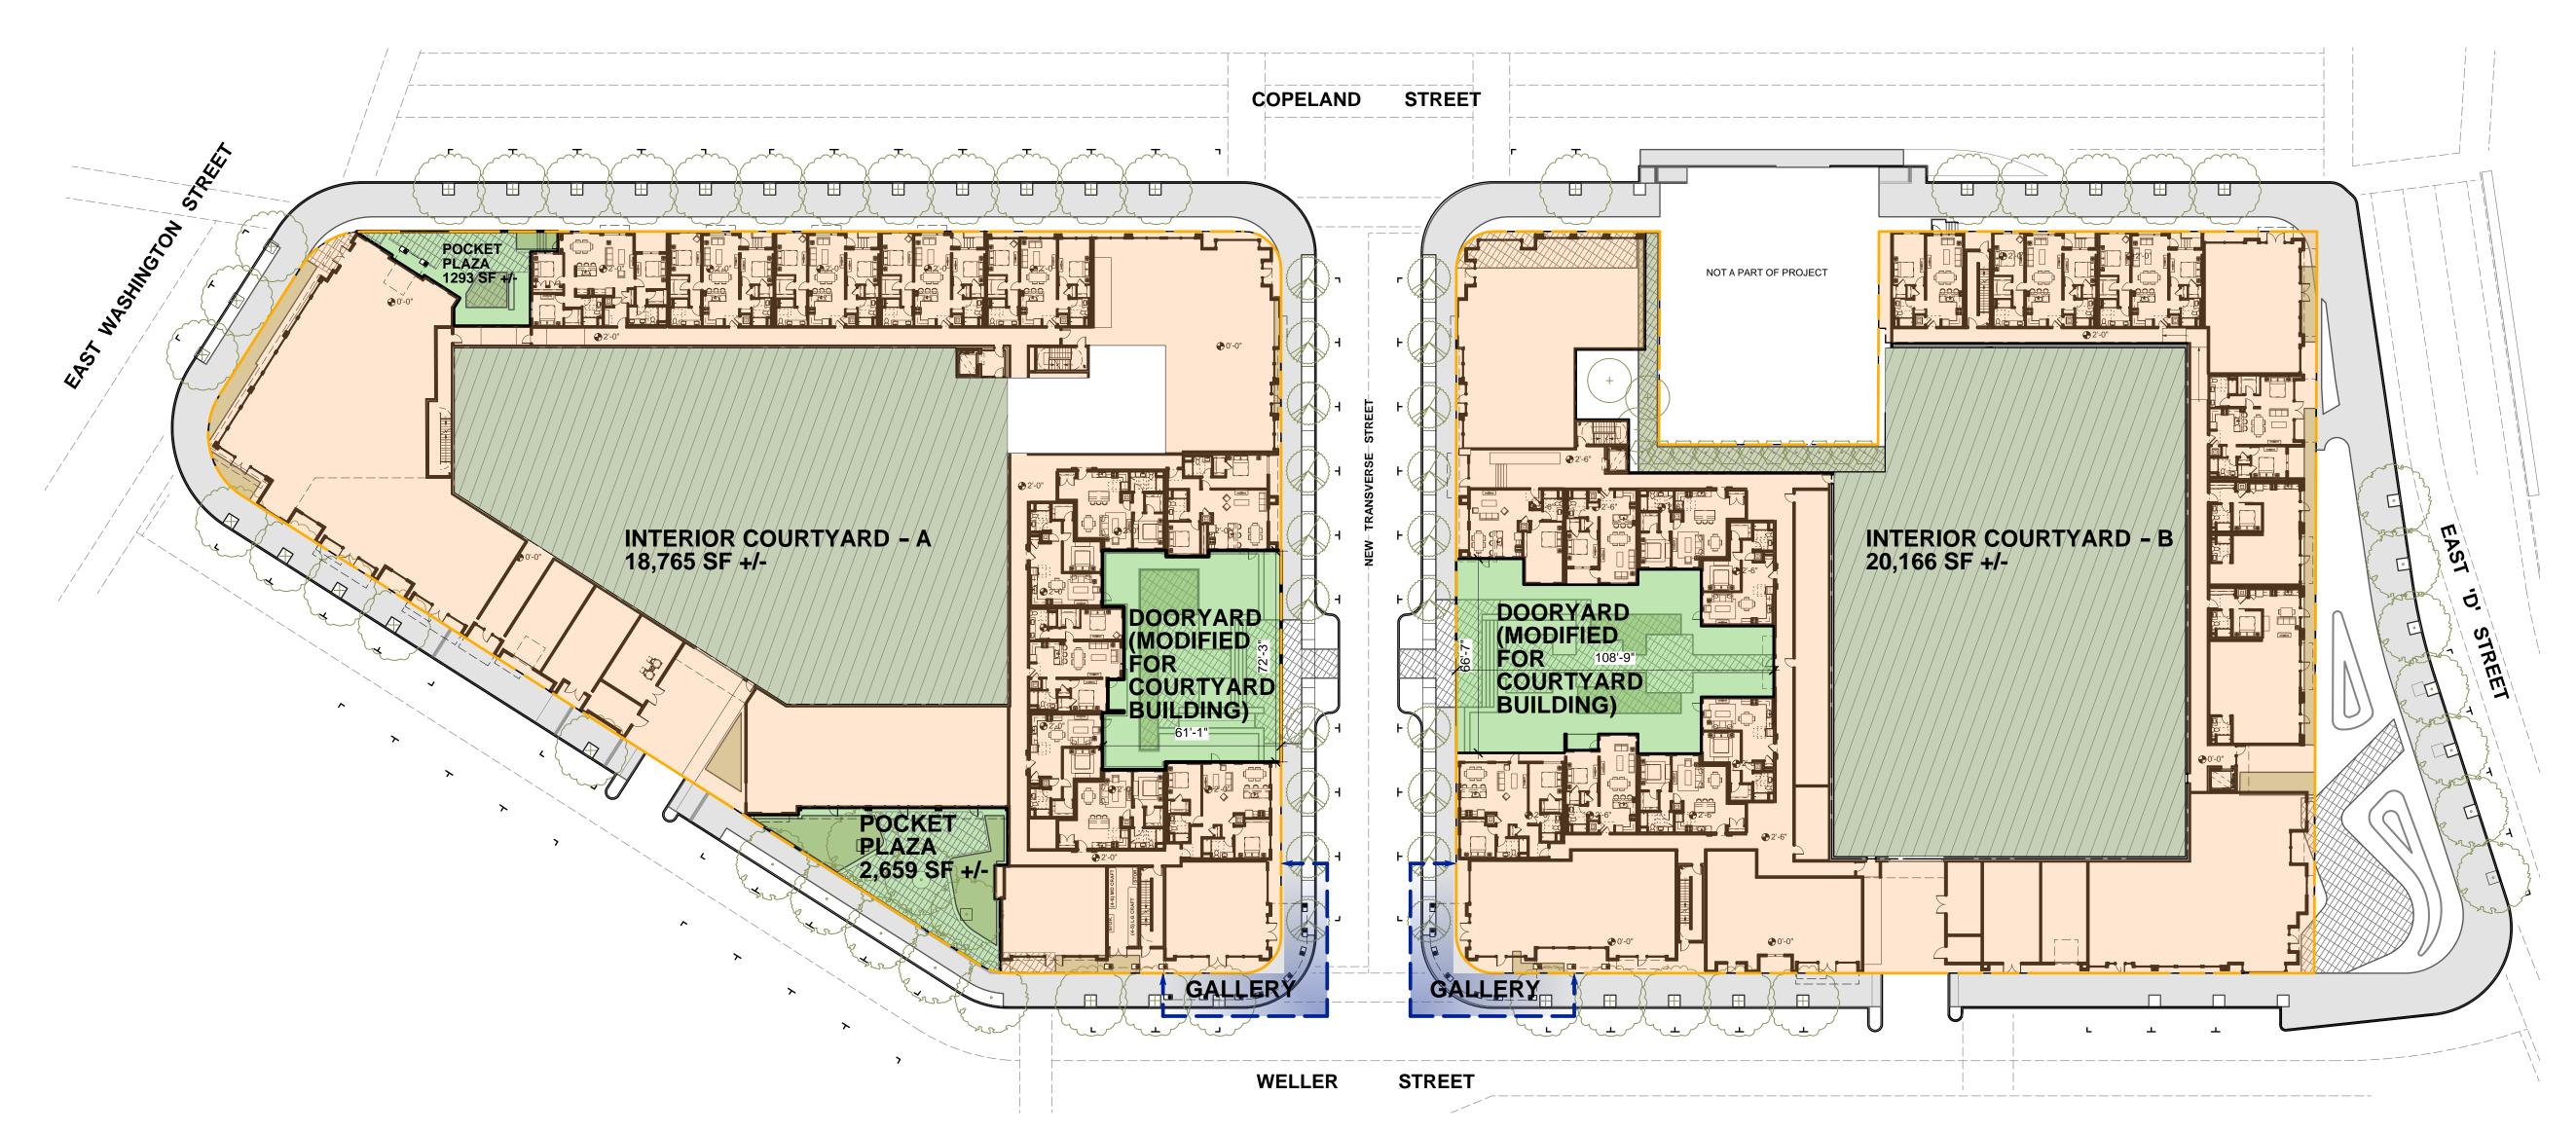
•FINISH LEVEL ABOVE SIDEWALK: 3'-6" MAX.

"THE MAXIMUM BUILDING HEIGHT IN THE T5 ZONE SHALL BE 4 STORIES" THE PROPOSED BUILDING DOES NOT REQUIRE EXCEPTION

PROPERTY LINE/ END OF SIDEWALK EASEMENT

CIVIC SPACES: COURTYARDS, POCKET PLAZAS

INTERIOR COURTYARD



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BUILDING PLACEMENT & CIVIC REQ'S



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BUILDING BLOCK DIAGRAM

PROJECT NO. 1618 DRAWN BY IP

SHEET SIZE: 30 x 42

OWNER/APPLICANT

PACIFICA COMPANIES
CAREY ALGAZE
1775 HANCOCK STREET, SUITE 200
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619-296-9000 VOICE
619-296-9090 FAX

(calgaze@pacificacompanies.com)

TITLE SHEET

CONTEXT PLAN

EXISTING CONDITIONS EXHIBIT

TENTATIVE PARCEL MAP

PROJECT STREETS EXHIBIT

STREET SECTIONS - 'D' STREET

PRELIMINARY GRADING PLAN - NORTH

PRELIMINARY GRADING PLAN - SOUTH

EXISTING PUBLIC ON-STREET PARKING EXHIBIT

OFF-SITE CIRCULATION PLAN

PRELIMINARY UTILITY PLAN

SIGNING AND STRIPING PLAN

C-18 PFD LADDER TRUCK STAGING EXHIBIT

LID-1 STORMWATER MITIGATION PLAN

PROJECT PROPOSED PARKING PLAN

WELLER STREET PARKING EXHIBIT

PFD LADDER TRUCK CIRCULATION EXHIBIT

STREET SECTIONS - WELLER STREET & E. WASHINGTON STREET

STREET SECTIONS - COPELAND AND TRANSVERSE STREETS


ON-SITE ADA COMPLIANT ROUTING AND CIRCULATION PLAN


SHEET INDEX

SPAR RESUBMIT 2 1.31.19

APN 007-143-003, 004, 007, 008, 014 AND 015

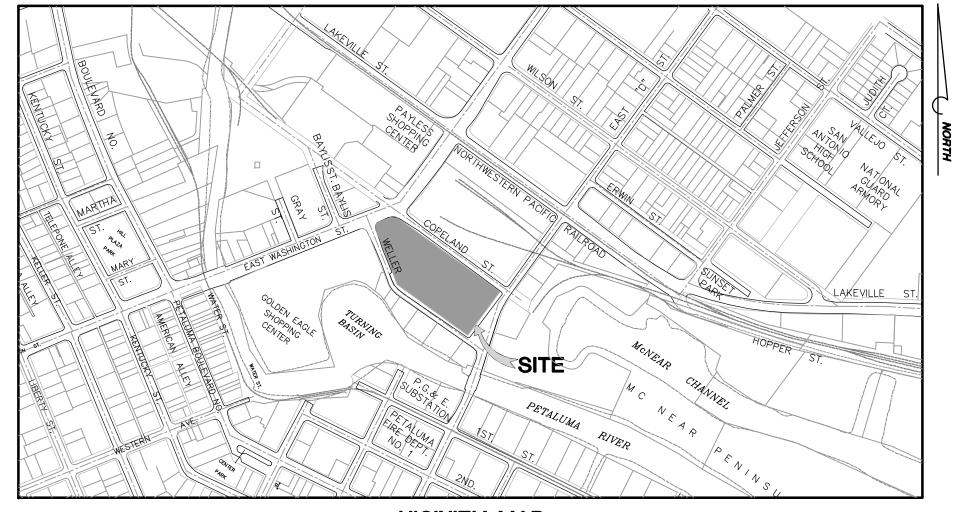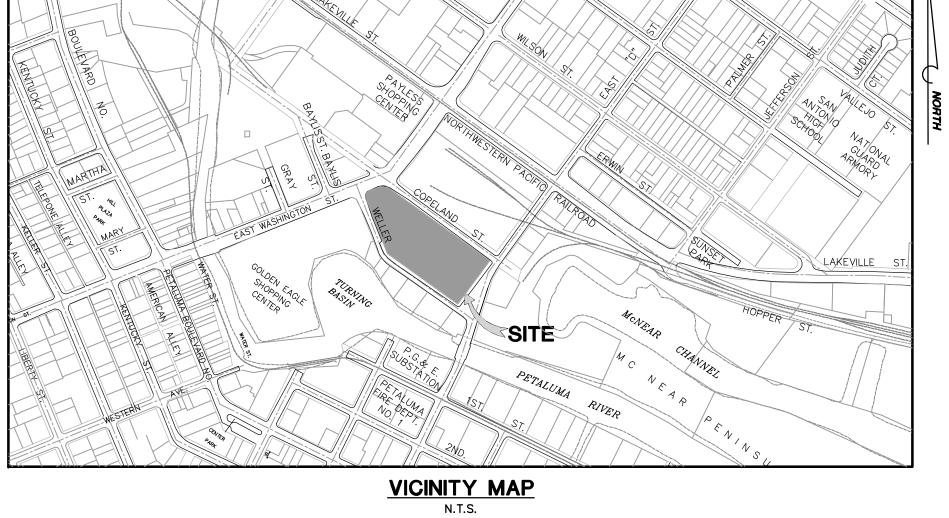HAYSTACK PACIFICA MIXED-USE PROJECT CALIFORNIA **PETALUMA**







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lchan@engeo.com

HOLMES FIRE

WHITLOCK & WEINBERGER TRANSPORTATION, INC.

1212 4TH STREET

SAN FRANCISCO, CA 94103

QUADRIGA LANDSCAPE ARCHITECTURE

SANTA ROSA, CALIFORNIA 95401

CIVIL ENGINEER LAND SURVEYOR

LANDSCAPE

ARCHITECT

STRUCTURAL

ENGINEER

TRAFFIC

ENGINEER

GEOTECHNICAL

ASSESSMENT/

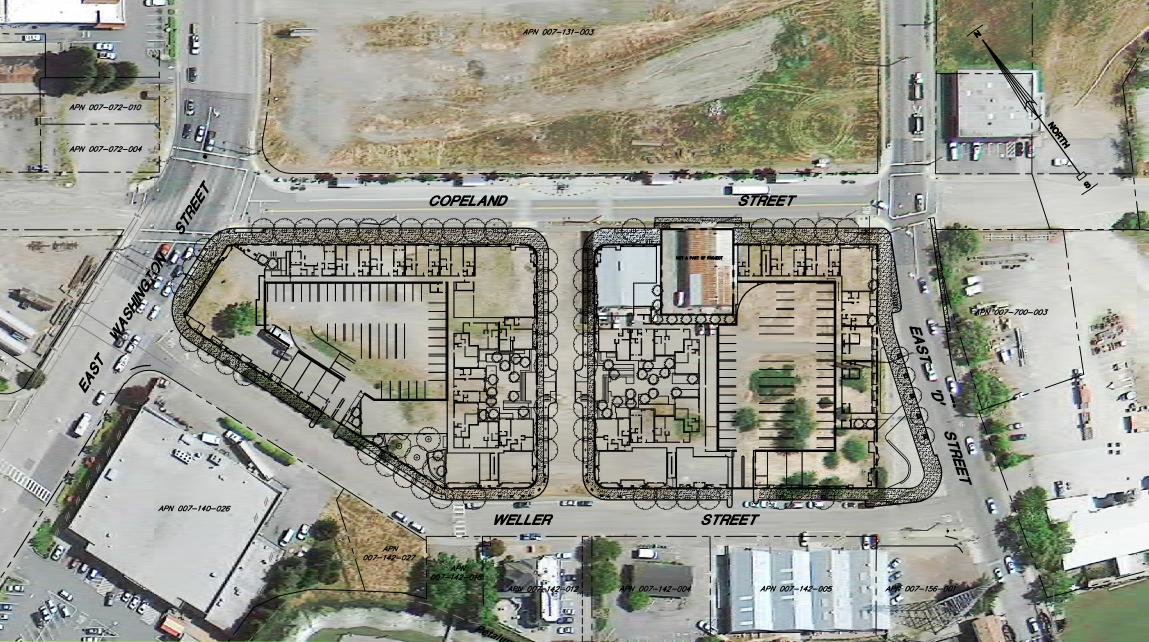
FIRE ENGINEERING

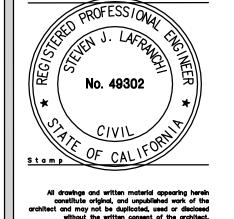
ENGINEER

NOISE

STEVEN J. LAFRANCHI & ASSOCIATES, INC. 140 SECOND STREET, SUITE 312 PETALUMA, CALIFORNIA 94952

SITE DIAGRAM SCALE: 1"=100'









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& ASSOCIATES, INC.
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LAND SURVEYORS
LAND PLANNERS

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No. 49302

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C-2

Scale: AS SHOWN

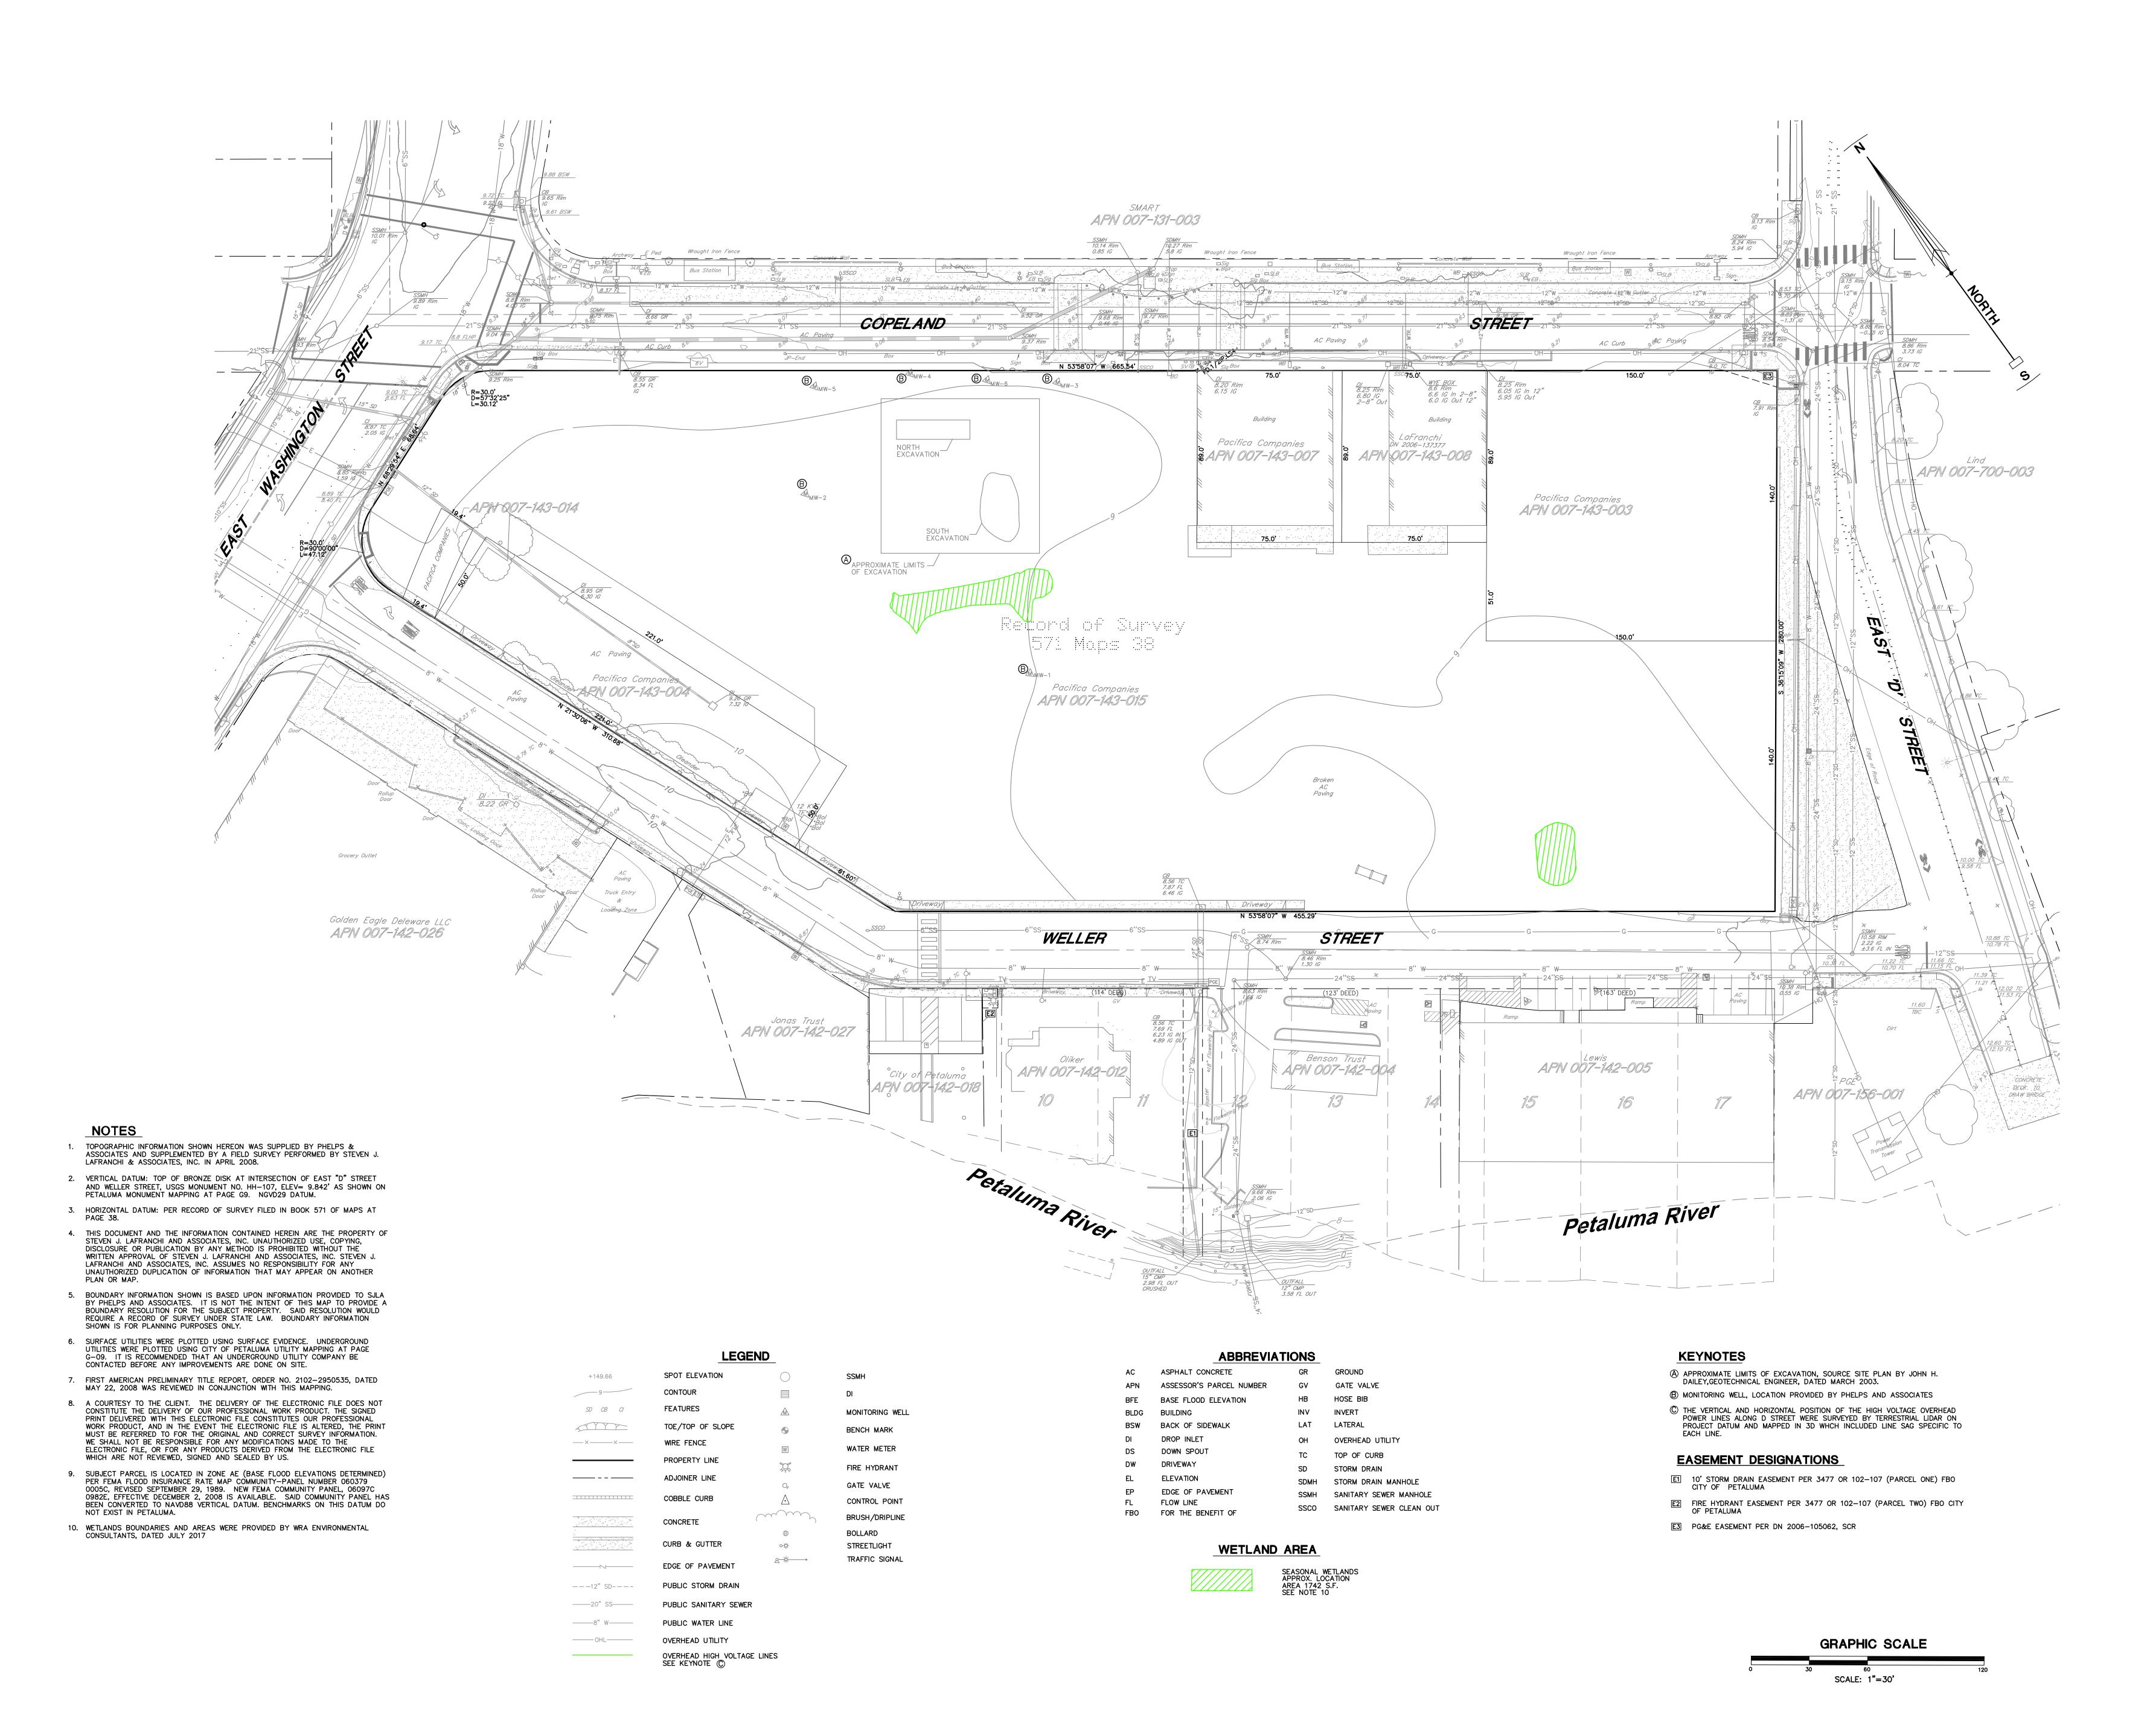
Project No. 121559 Drawn By: HSM

Sheet Size: 30 x 42

GRAPHIC SCALE

PHIC SCALE

 LAND USE DESIGNATIONS SHOWN HEREON ARE PER THE CITY OF PETALUMA CPSP LAND USE MAP FOR THE PETALUMA GENERAL PLAN 2025.



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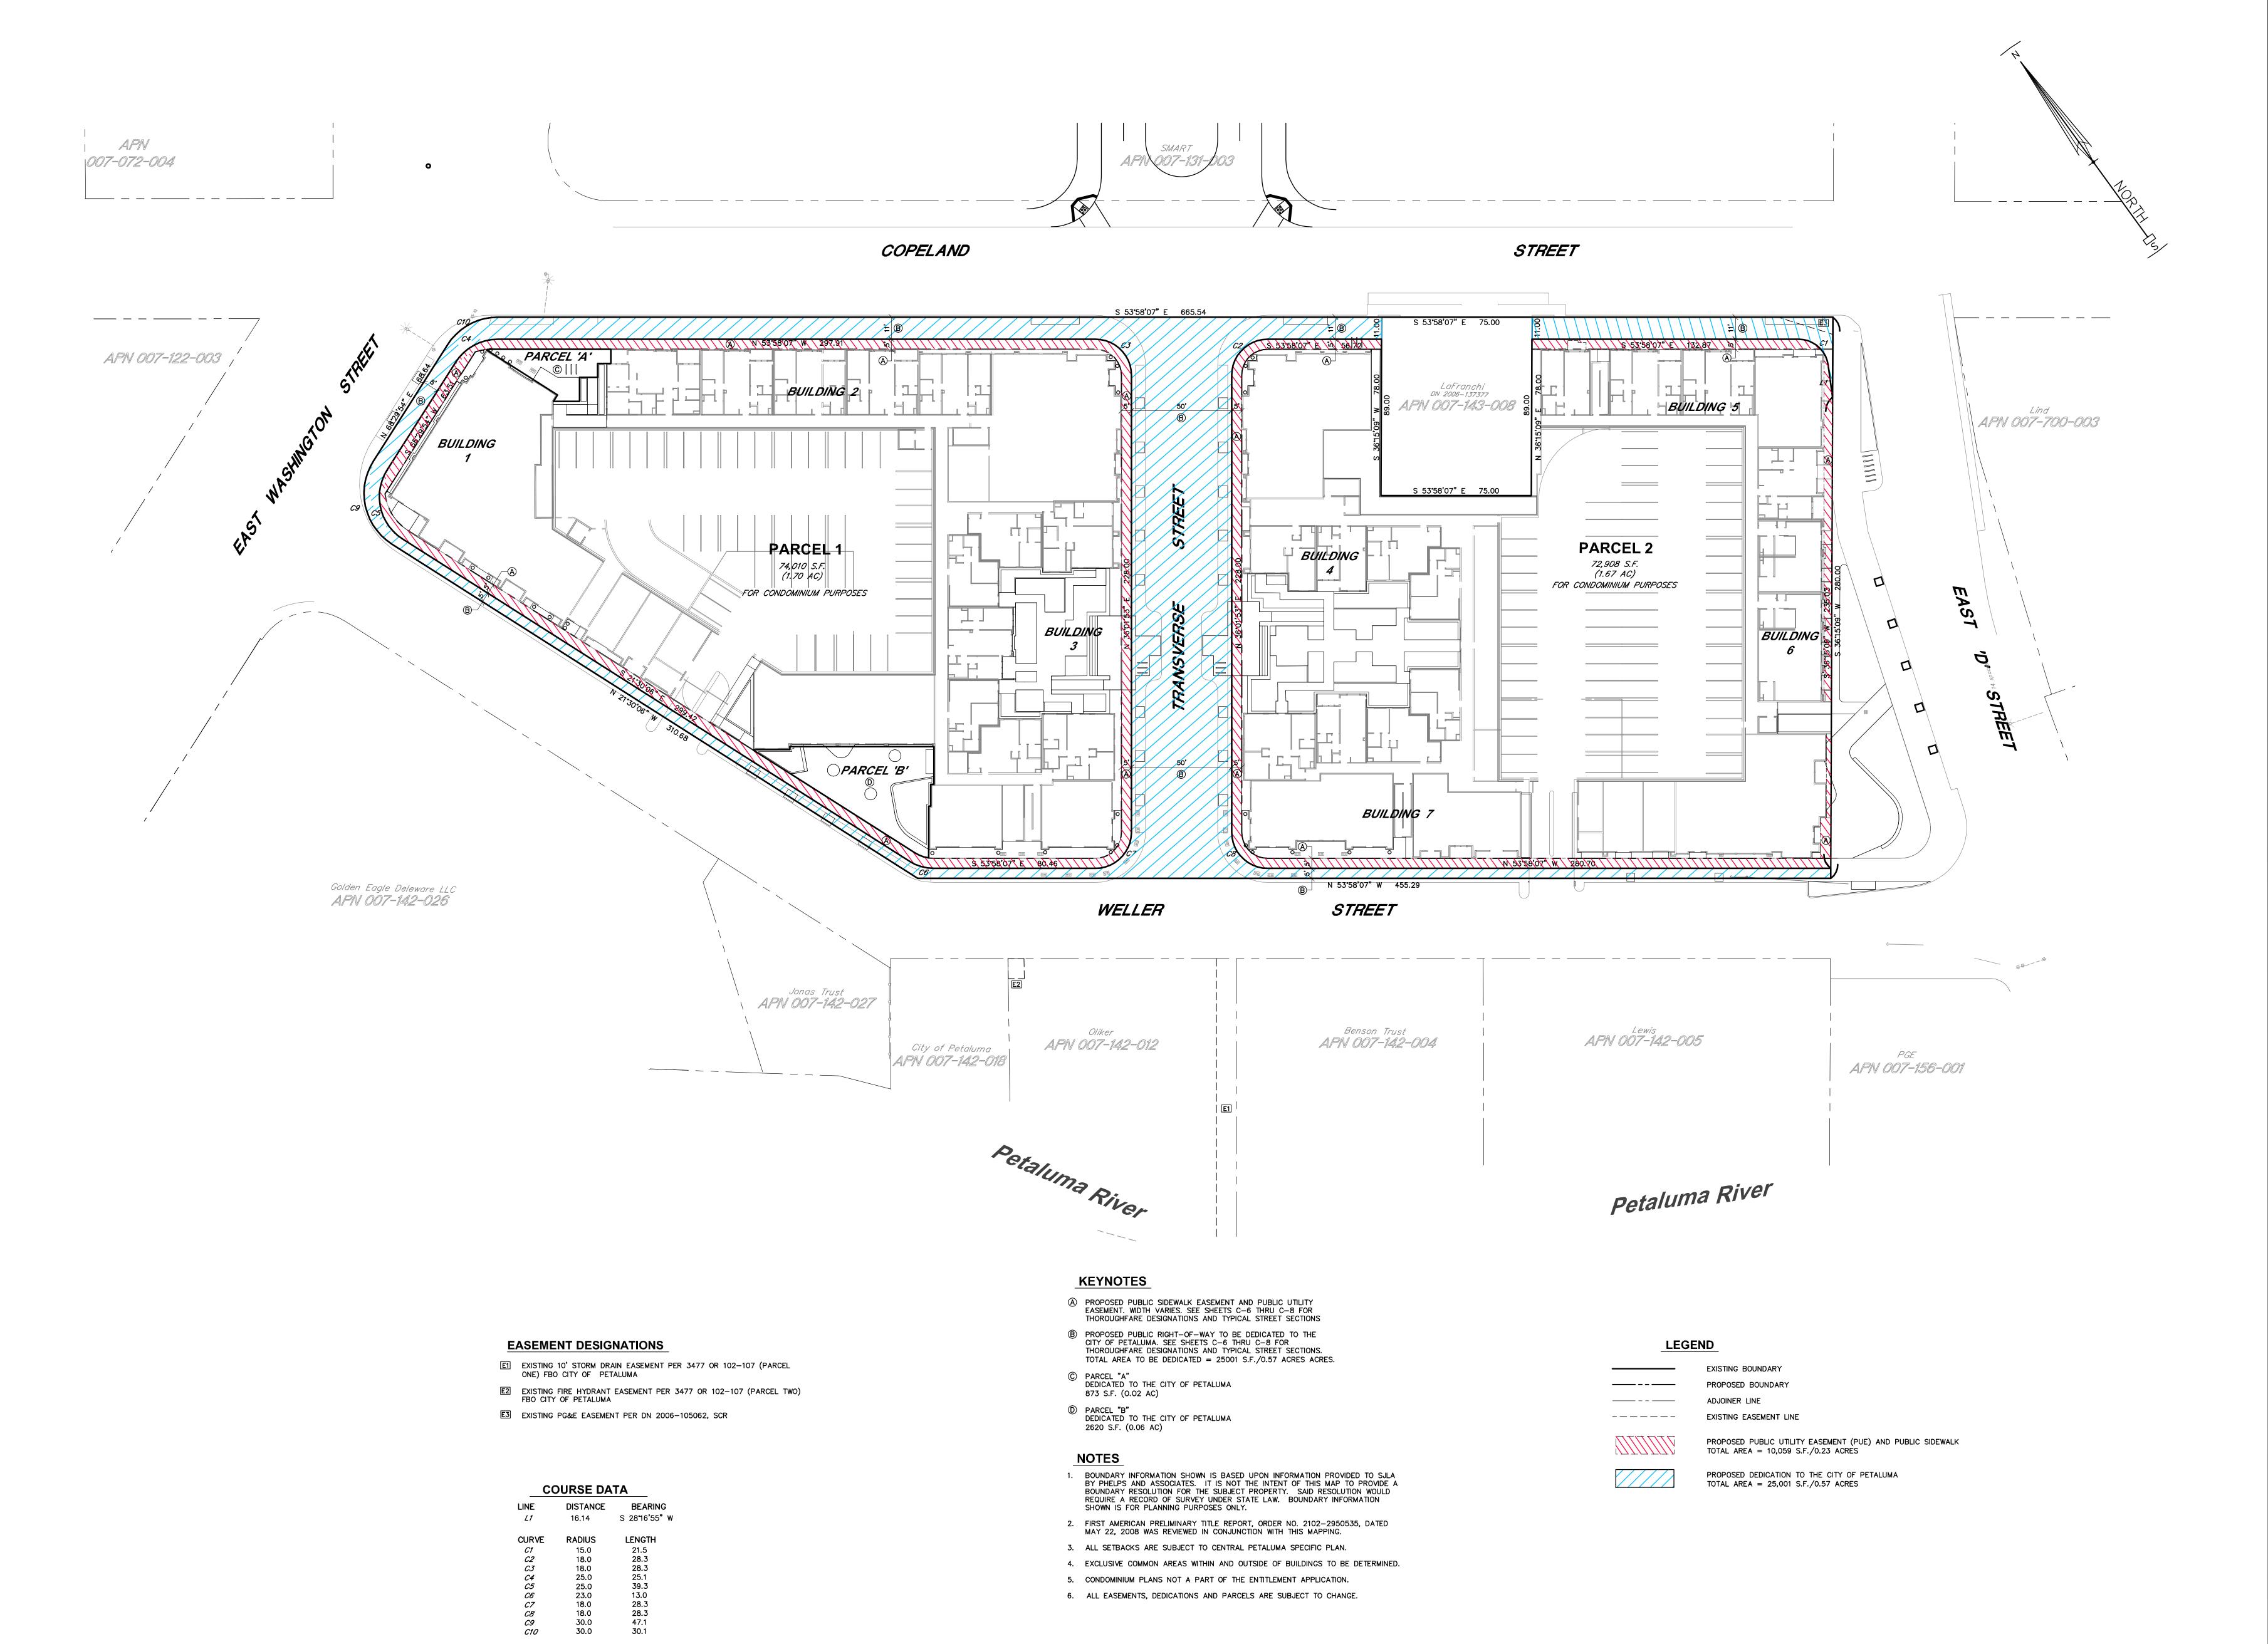
NDITIONS

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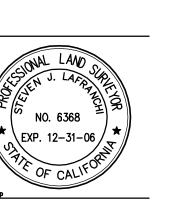


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PARCEL STACK
A, CALIFORNIA

Issue	Date
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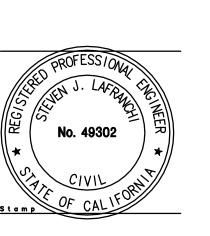
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LUMA THEATRE SQUARE
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PROJECT STREETS EXHIB
HAYSTACK
PETALUMA, CALIFORNIA

SPAR RESUBMIT 1.31.19



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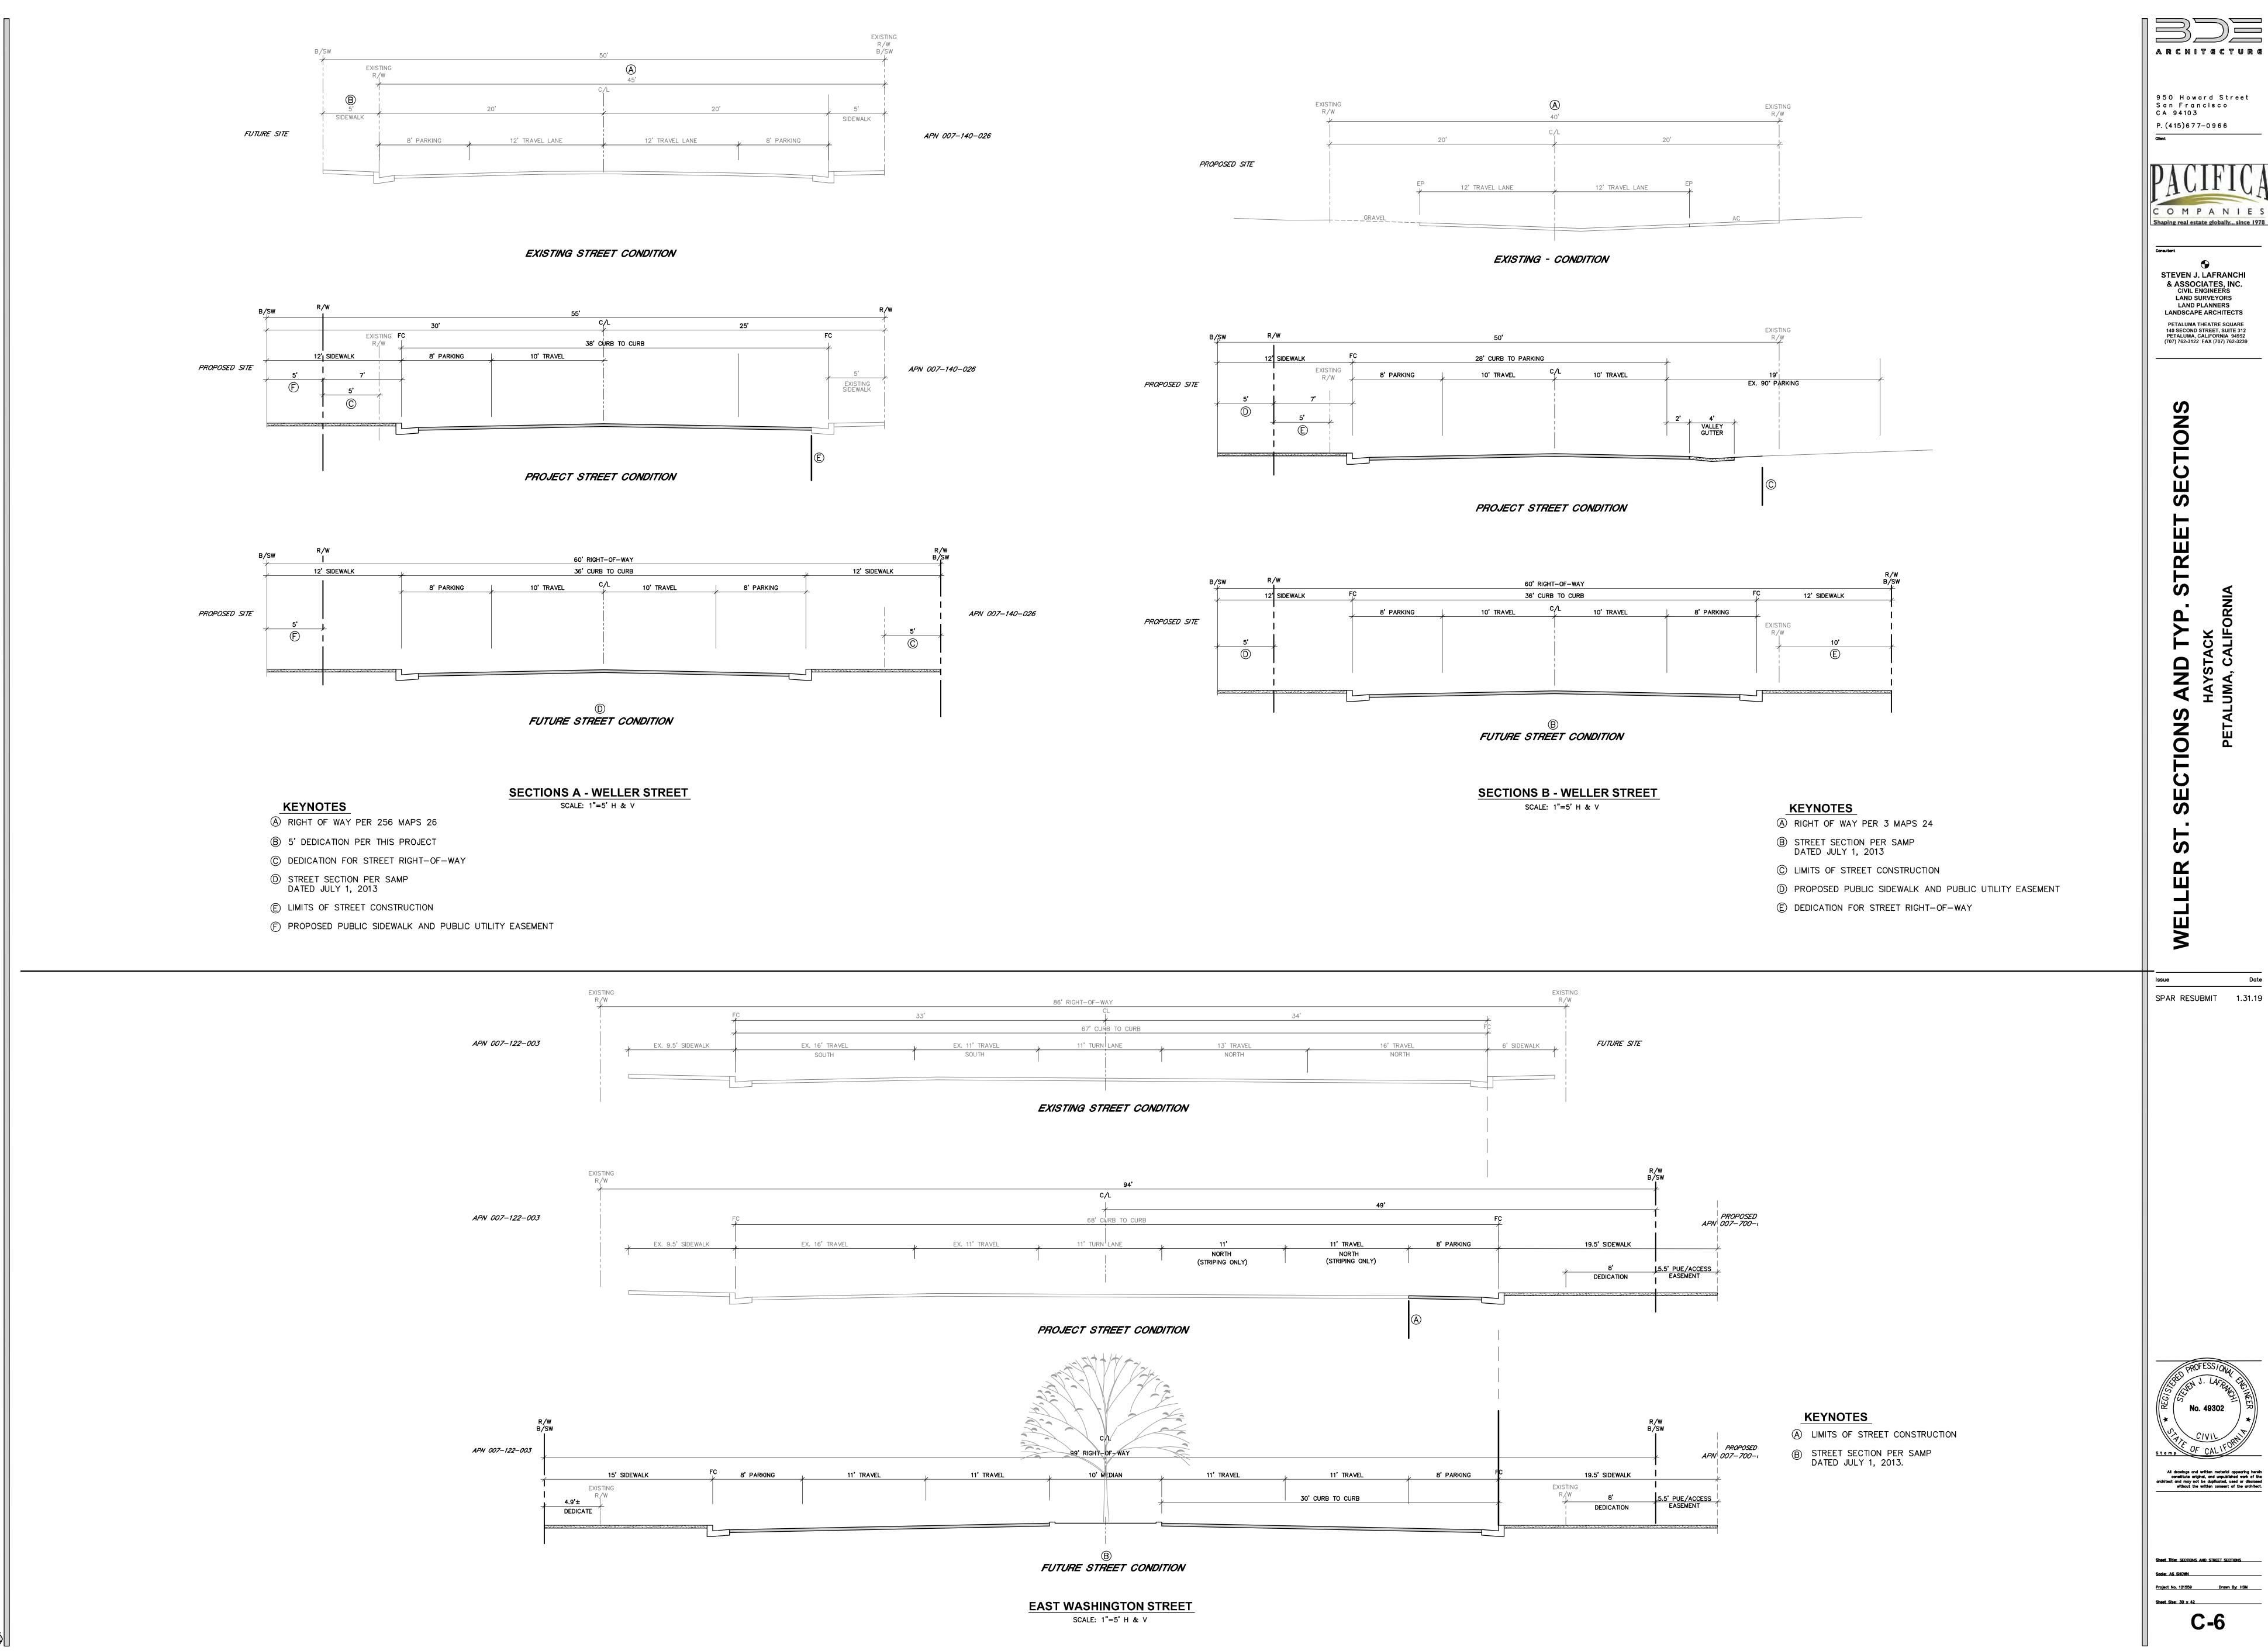
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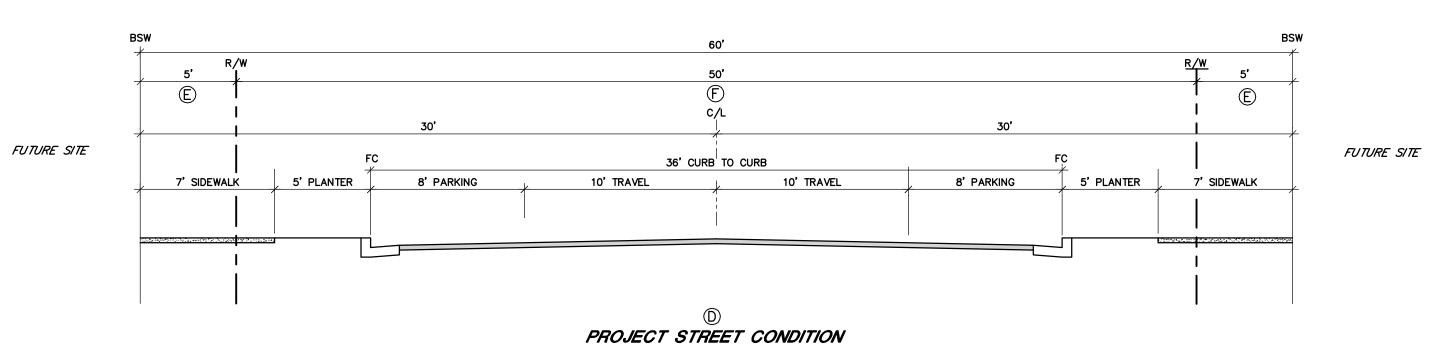
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SPAR RESUBMIT 1.31.19

SECTIONS C AND D - COPELAND STREET

FUTURE STREET CONDITION

SCALE: 1"=5' H & V



TRANSVERSE - STREET SECTION

SCALE: 1"=5' H & V

KEYNOTES

- A RIGHT OF WAY PER 3 MAPS 24
- B HOLD EXISTING FACE OF CURB ON TRANSIT SIDE FOR FUTURE SECTION.
- © LIMITS OF PROPOSED STREET CONSTRUCTION
- D STREET SECTION PER SAMP DATED JULY 1, 2013
- © PROPOSED PUBLIC SIDEWALK AND PUBLIC UTILITY EASEMENT
- © DEDICATION FOR STREET RIGHT-OF-WAY

AND AYSTACI MA, CALI

ARCHITECTURE

950 Howard Street San Francisco CA 94103

COMPANIES

STEVEN J. LAFRANCHI

& ASSOCIATES, INC.
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LAND PLANNERS

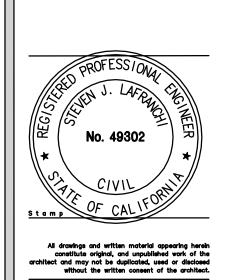
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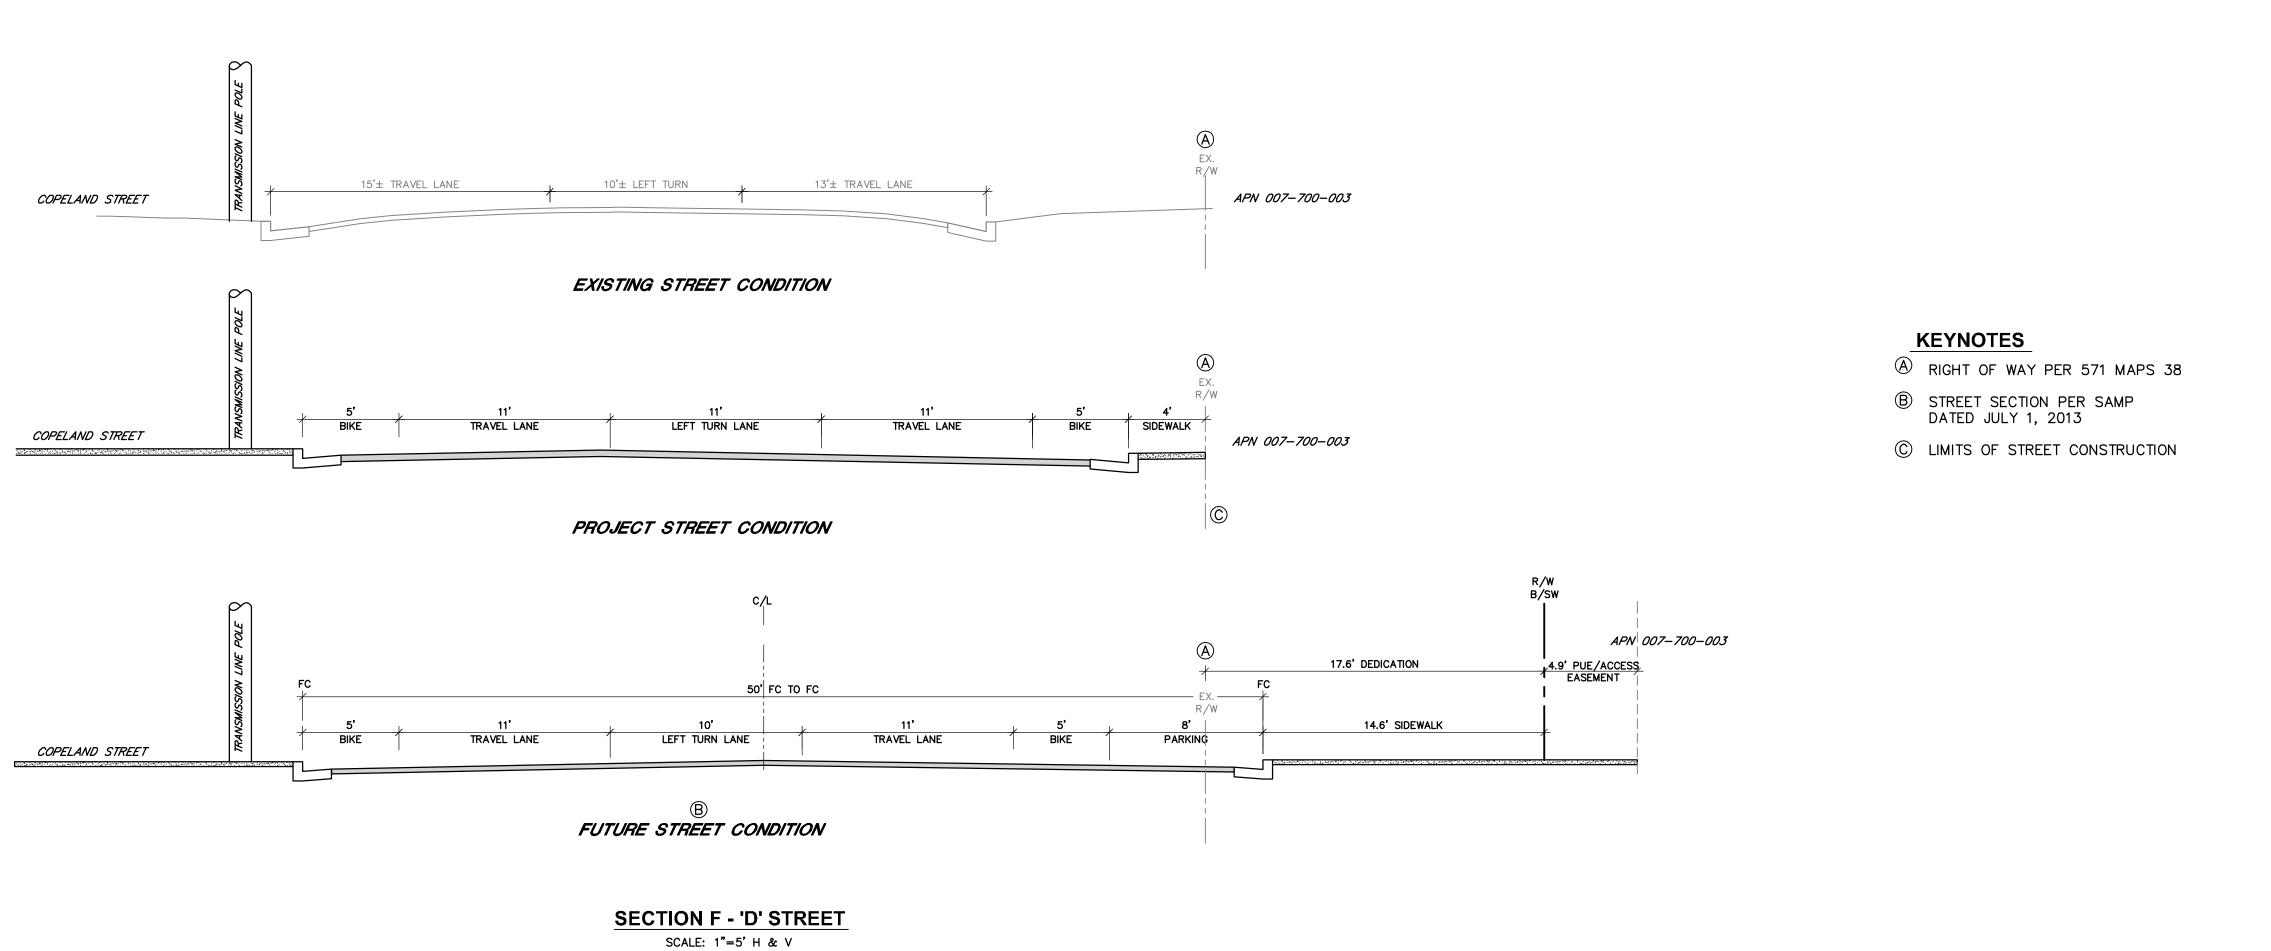
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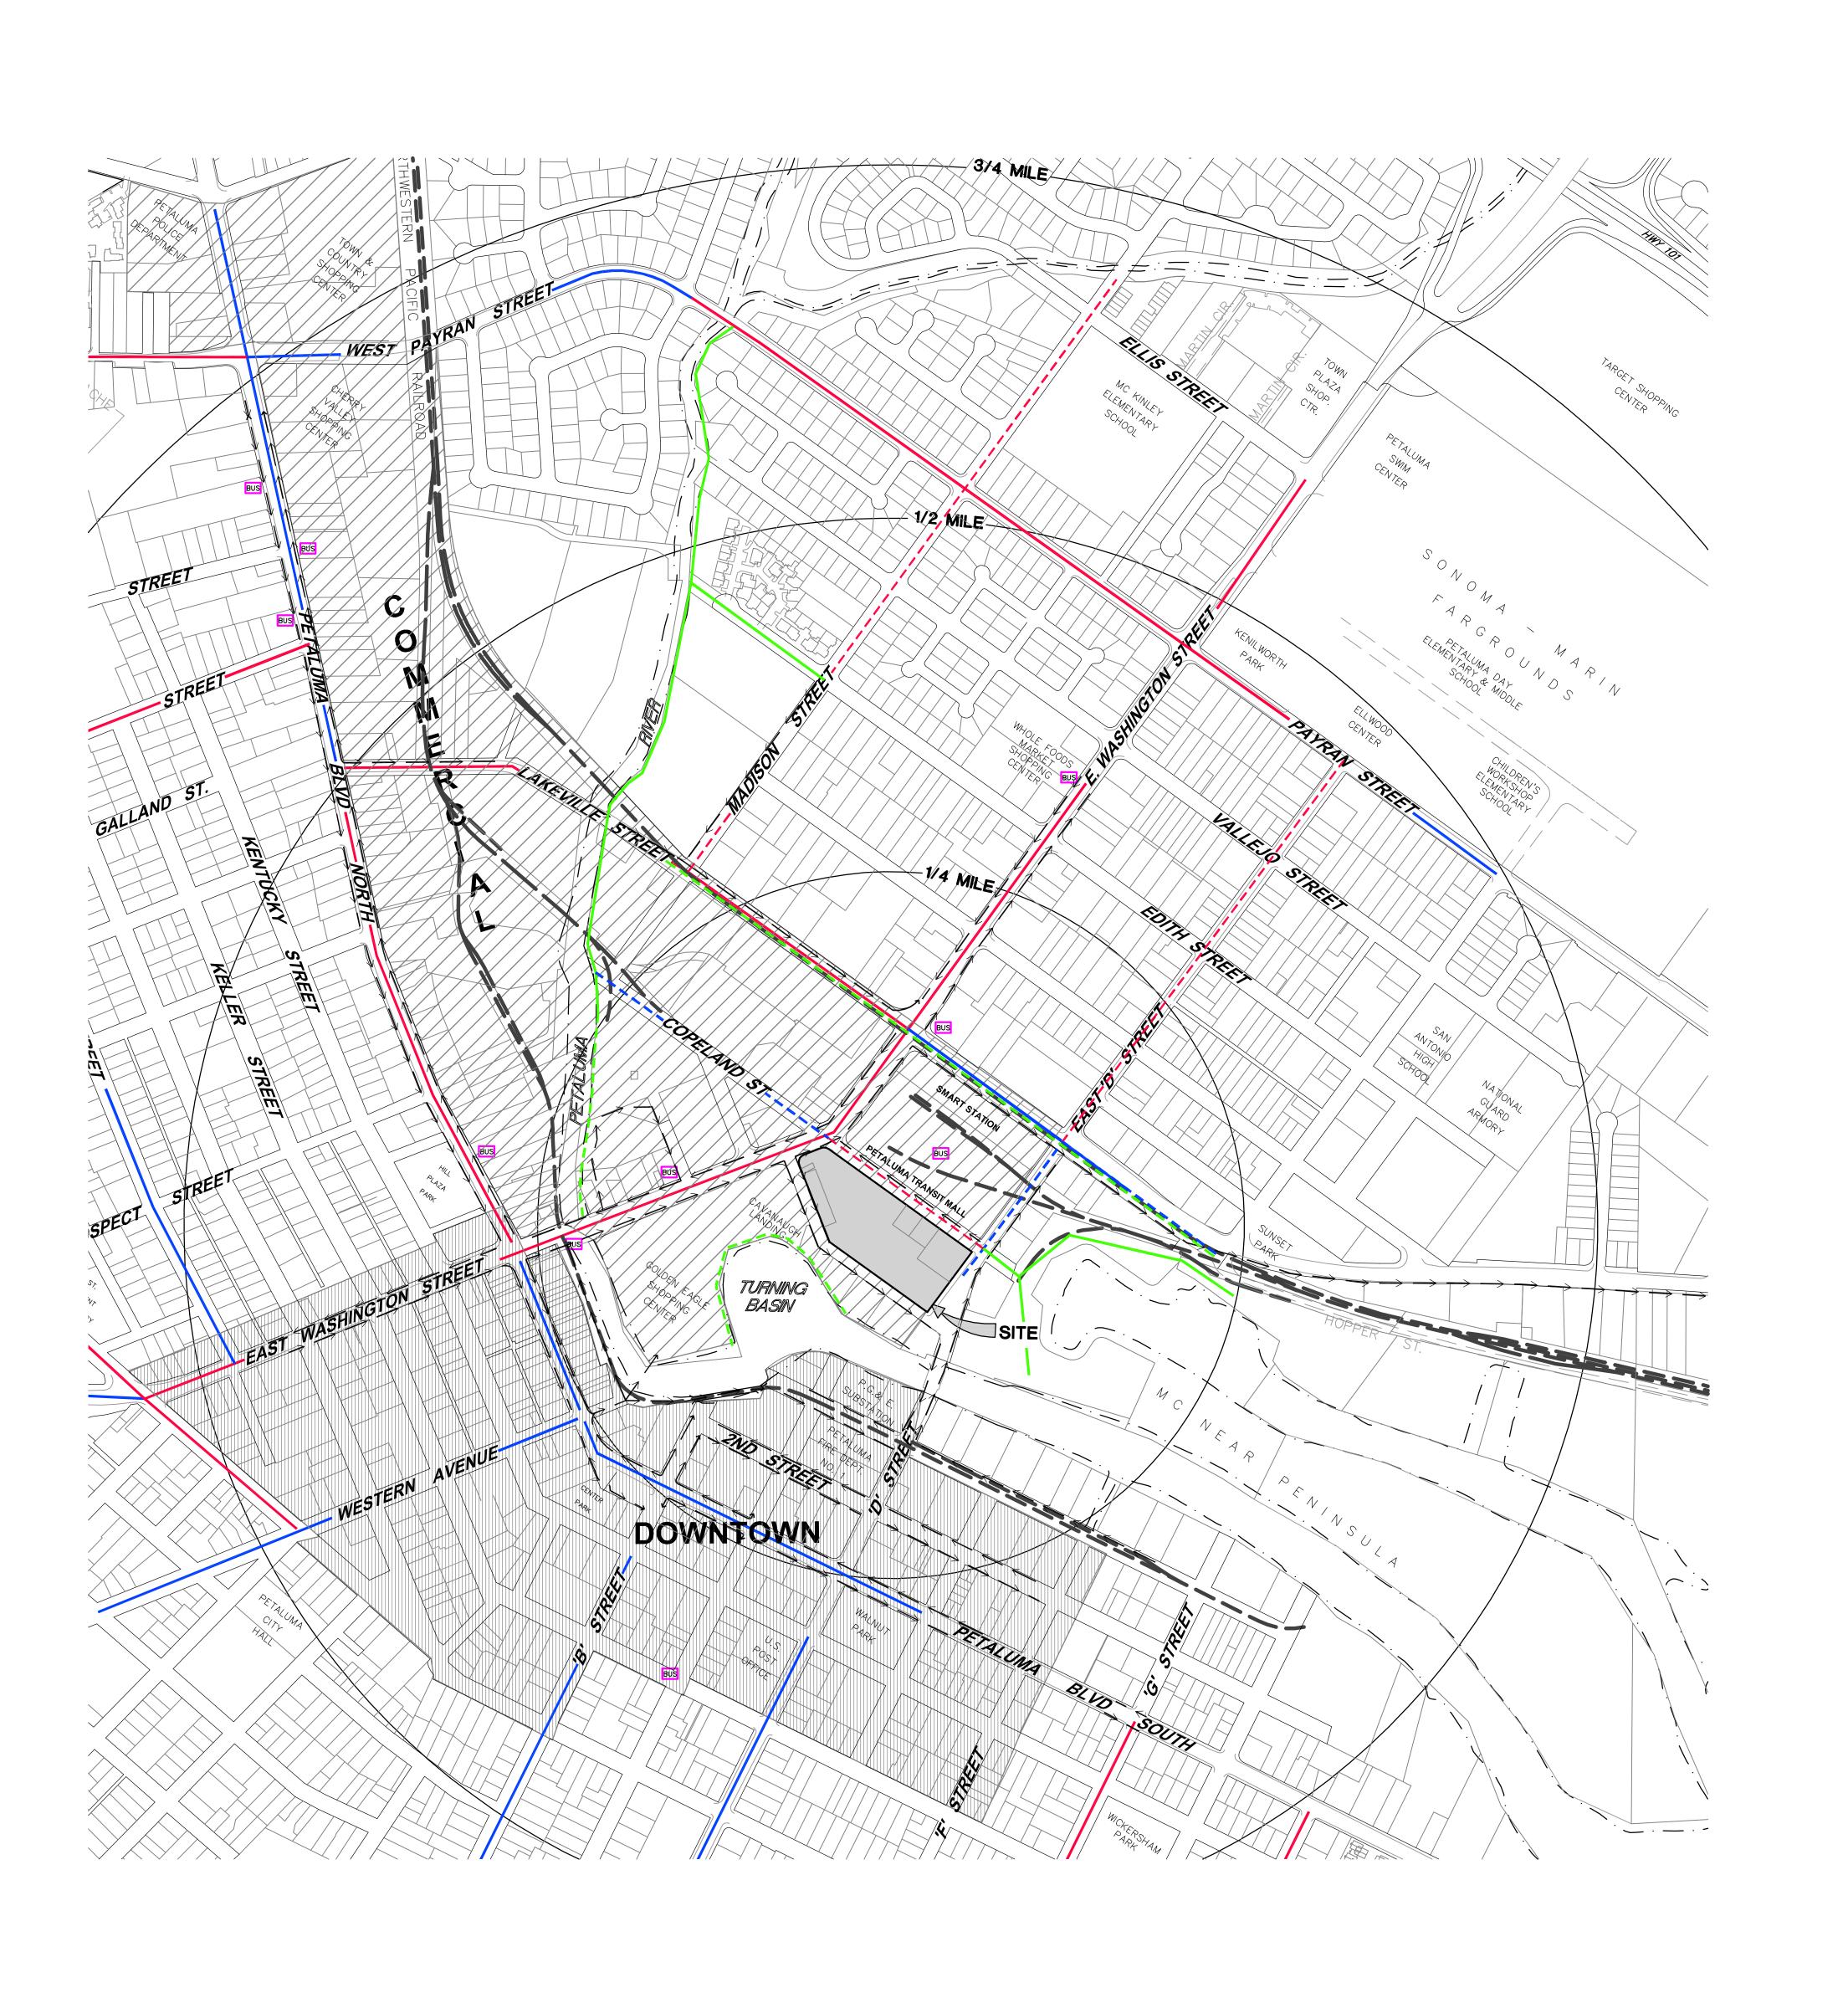
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Project No. 121559 Drawn By: HSM Sheet Size: 30 x 42



LEGEND PEDESTRIAN $- \longleftarrow \longleftarrow \longleftarrow \longleftarrow \longleftarrow$ ACCESSIBILITY TO COMMERCIAL

BICYCLE CLASS I EXISTING — — — CLASS I PROPOSED CLASS II EXISTING - CLASS II PROPOSED CLASS III EXISTING - CLASS III PROPOSED RAILROAD/SMART RAILROAD TRACKS

BUS STOP LOCATION

1. SEE SHEET C-10 FOR ON-SITE CIRCULATION INFORMATION.

INFORMATION FOR CIRCULATION IS BASED ON THE CITY OF PETALUMA BICYCLE AND PEDESTRIAN FACILITIES MAP DATED FEBRUARY 13, 2014.

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C-9

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ARCHITECTURE

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OF

CUL AYSTA MA, CA

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A NEW ADA COMPLIANT RAMP B EXISTING ADA COMPLIANT RAMP TO REMAIN

— ← ←	MAJOR VEHICULAR ACCESS
─ ← ←	MINOR VEHICULAR ACCESS
→	CLASS II BIKE PATH
→	CLASS III BIKE PATH
. 0 . 0 . 0 .	ADA PEDESTRIAN CIRCULATION

1. SEE SHEET C-9 FOR OFF-SITE CIRCULATION INFORMATION.

2. INFORMATION FOR CIRCULATION IS BASED ON PETALUMA SMART RAIL STATION AREA MASTER PLAN THOROUGHFARE STANDARDS APPENDIX A DATED JULY 1, 2013. ARCHITECTURE

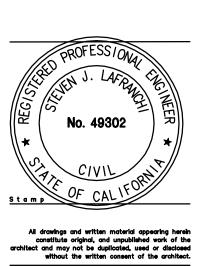
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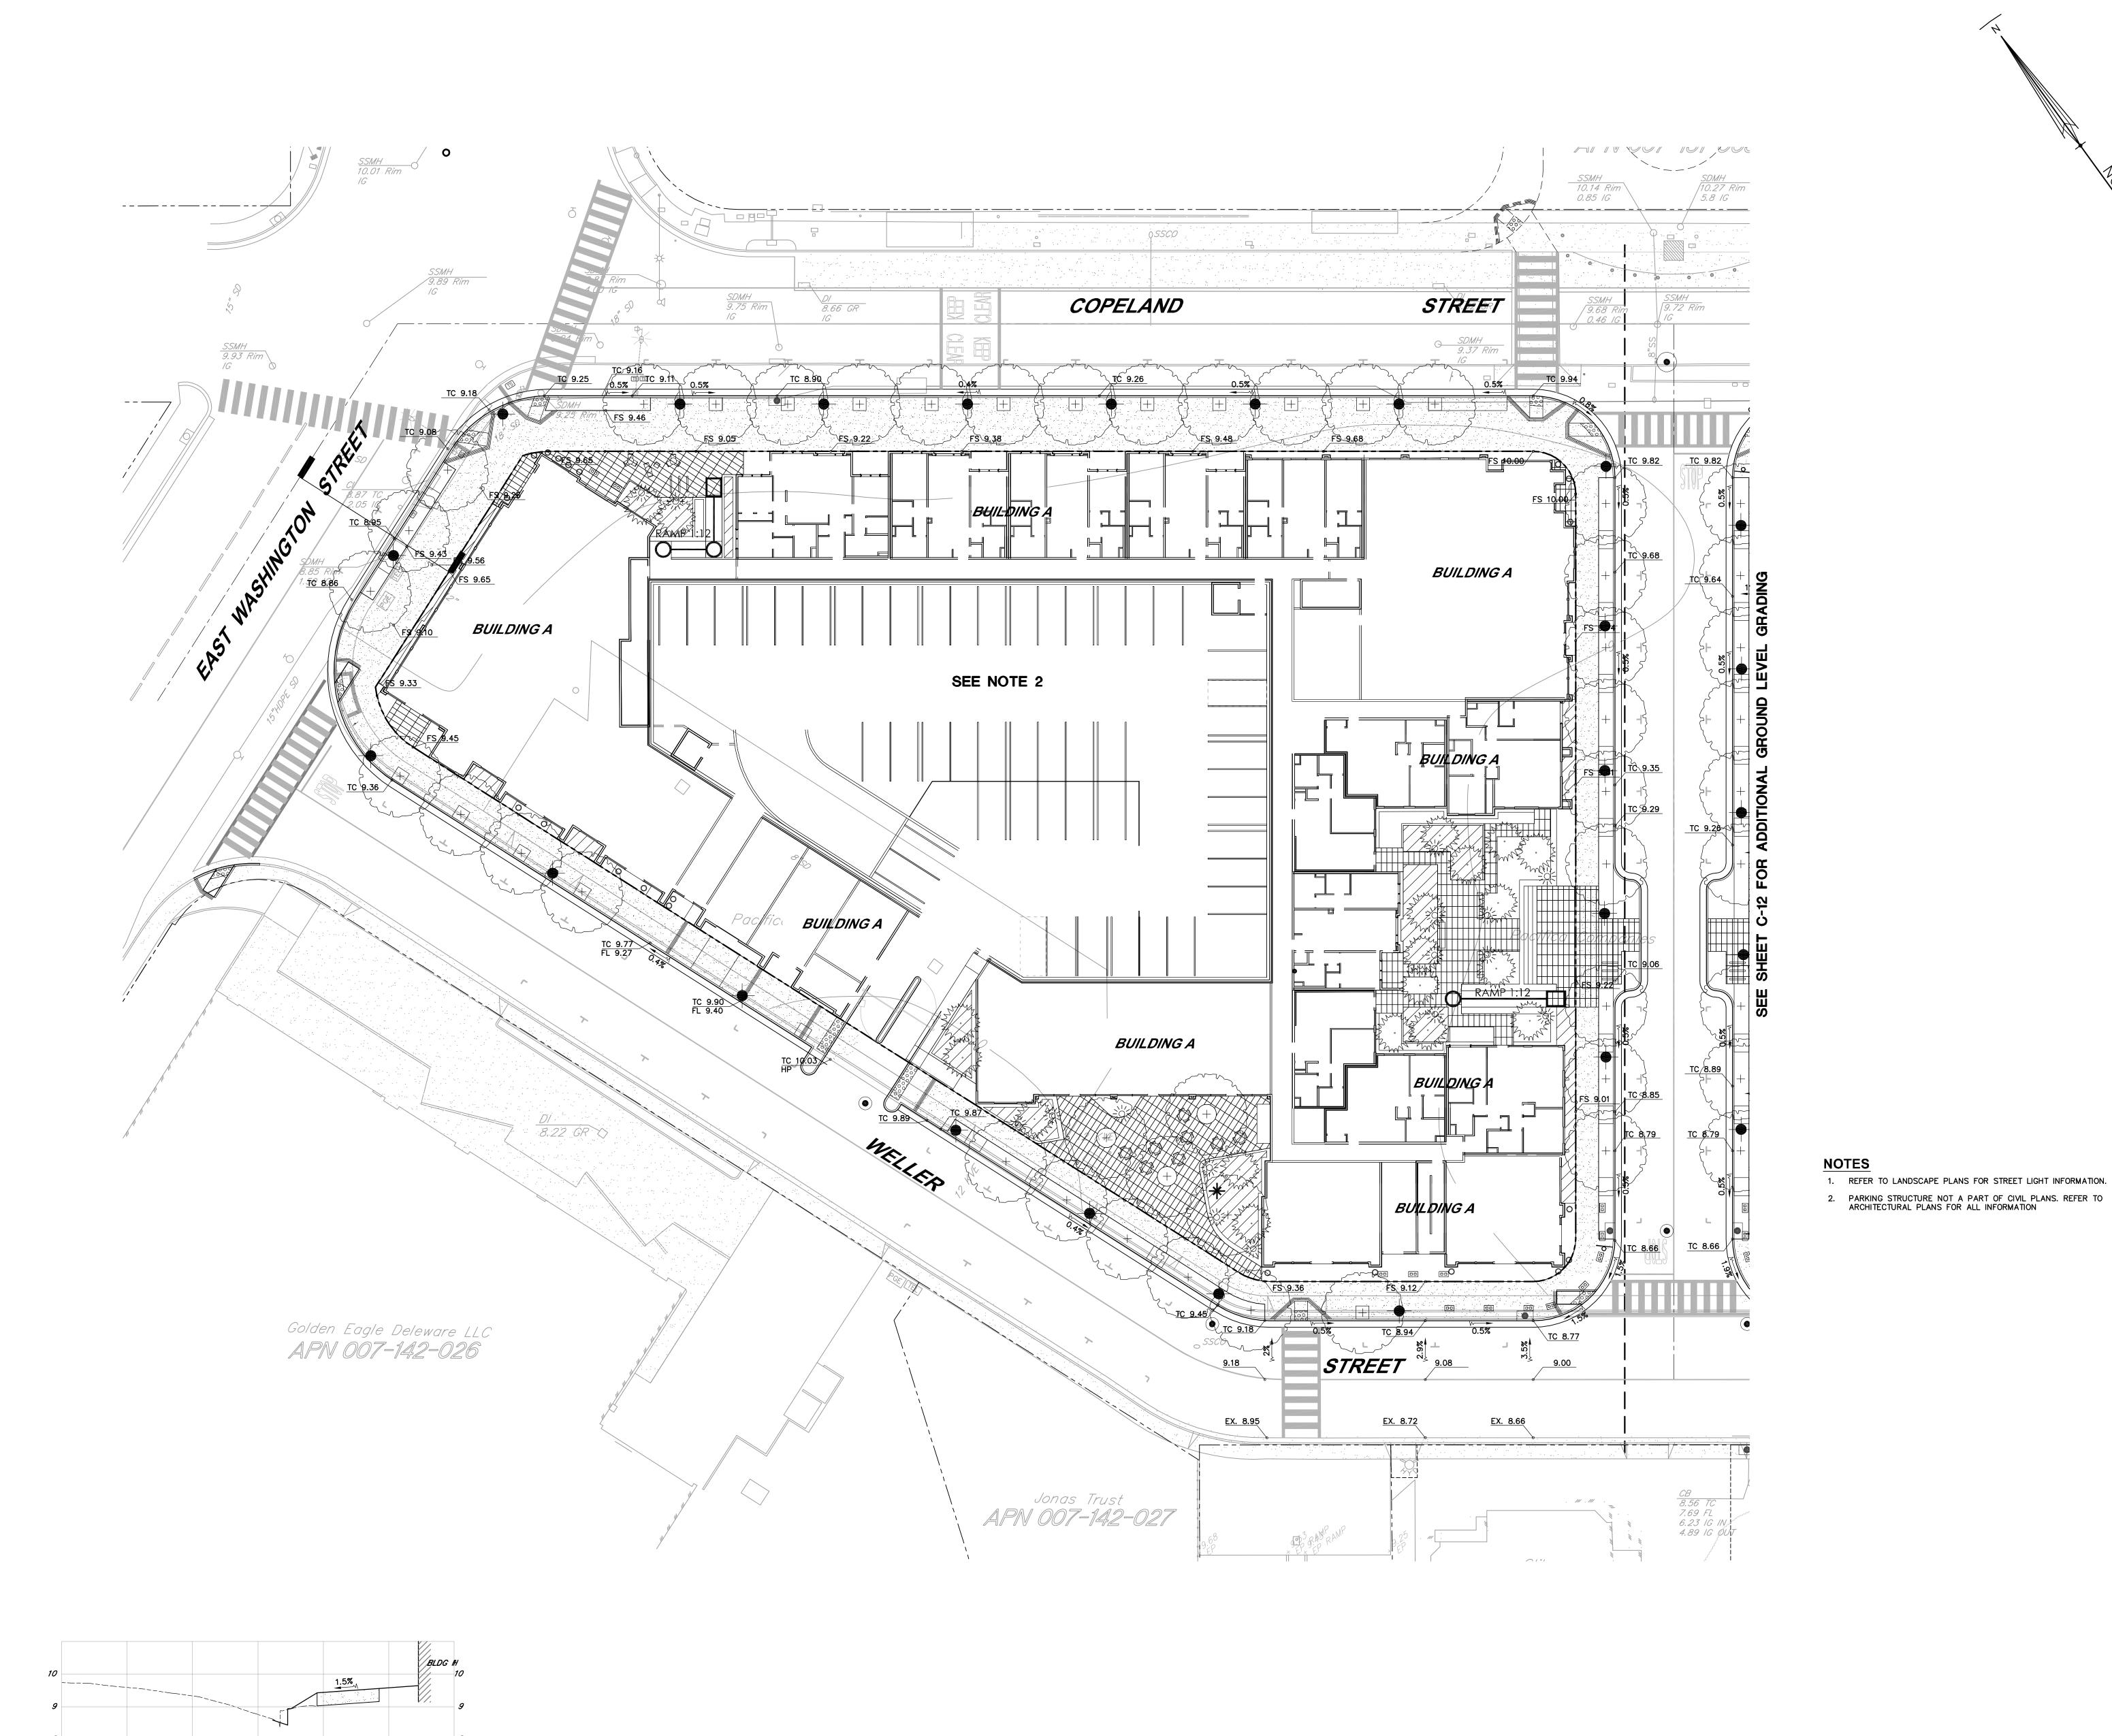
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Sheet Title: ON-SITE CIRCULATION PLAN Scale: AS SHOWN Project No. 121559 Drawn By: HSM Sheet Size: 30 x 42




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Sheet Title: GRADING PLAN NORTH Scale: AS SHOWN Project No. 121559 Drawn By: HSM Sheet Size: 30 x 42 C-11

SECTION A-A
SCALE: 1"=10'H, 1"=2'V


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C-12

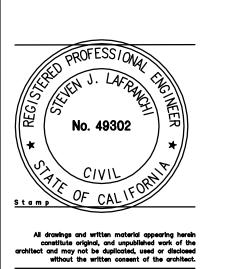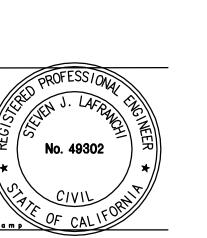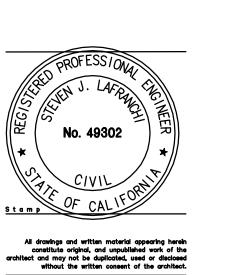
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