500 HOPER


SENIOR & MARKET-RATE HOUSING DEVELOPTMENT PLANNING RESUBMISSION 1 - MAY13, 2022









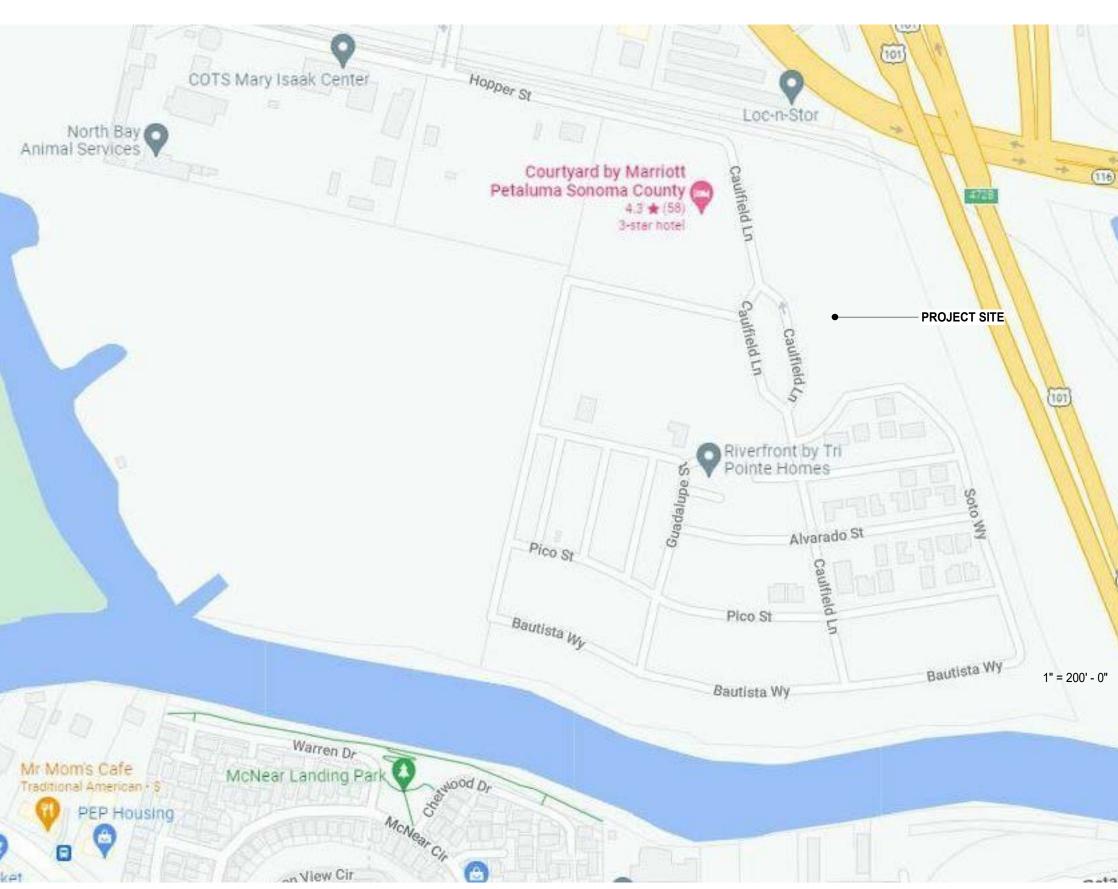

SITE VICINITY MAP

1" = 200' - 0"

• • AP7.01

WALL SECTION

ABBREVIATIONS 8

Top Of Steel

Top Of Wall

Towel Bar

Unfinished

Unless Otherwise Noted

Tread

Typical

Urinal

Varies

Veneer

Vertical

Vapor Barrier

Vertical Grain

Vinyl Base

Wainscot

Wall To Wall

Water Closet

Water Repellant

Welded Wire Fabric

Wall Hung

Waterstop

Wired Glass

Wire Mesh

Wood Base

Wrought Iron

Without

Wood

Window


Vinyl Acoustical Tile

Vinyl Composite Tile

Waterproofing, Waterproof

Water Proof Membrane

Weather Resistant Barrier

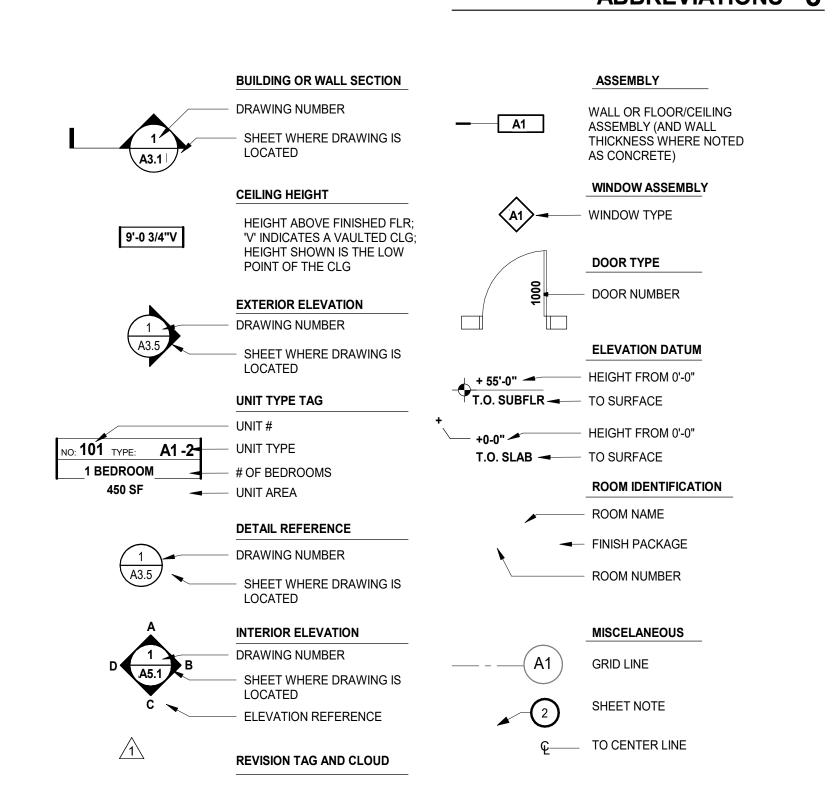

EPDM

EQ

EQP

FRM

Monome

Ethylene Propylene Diene

Equipment

Expansion Bolt

Expansion Joint

Face Of Concrete

Face Of Finish

Face Of Masonry

Finished Floor Elevation

Face Of Studs

Finish Floor

Finish (ed)

Fire Alarm

Fireproof

Floor (ing)

Floor Drain

Fluorescent

Flush Joint

Footing

Foundation

Frame (ing)

Furred (ing)

Gage, Gauge

Galvanized

Glass, Glazing

Glass Block

General Contractor

Fire-resistant

Fire-retardant

Estimate

Exhaust

Existing

Nominal

Number

Not In Contract

Not to Scale

On Center (s)

Opening

Opposite

Overhead

Painted

Partition

Particle Board

Particle Board

Plastic Laminate

Polyvinyl Chloride

Pounds Per Square

Pounds Per Square

Precast Concrete

Prefabricate (d)

Property Line

Pressure Treated

Rainwater Leader

Prefinished

Preformed

Radius

Recessed

Reference

Perforate (d)

Perimeter

Plate Glass

Plywood

Point

Over Flow Drain Overtiow Scuppe


Outside Diameter

Paper Towel Receptor

WSCT

WTW

SYMBOL LEGEND

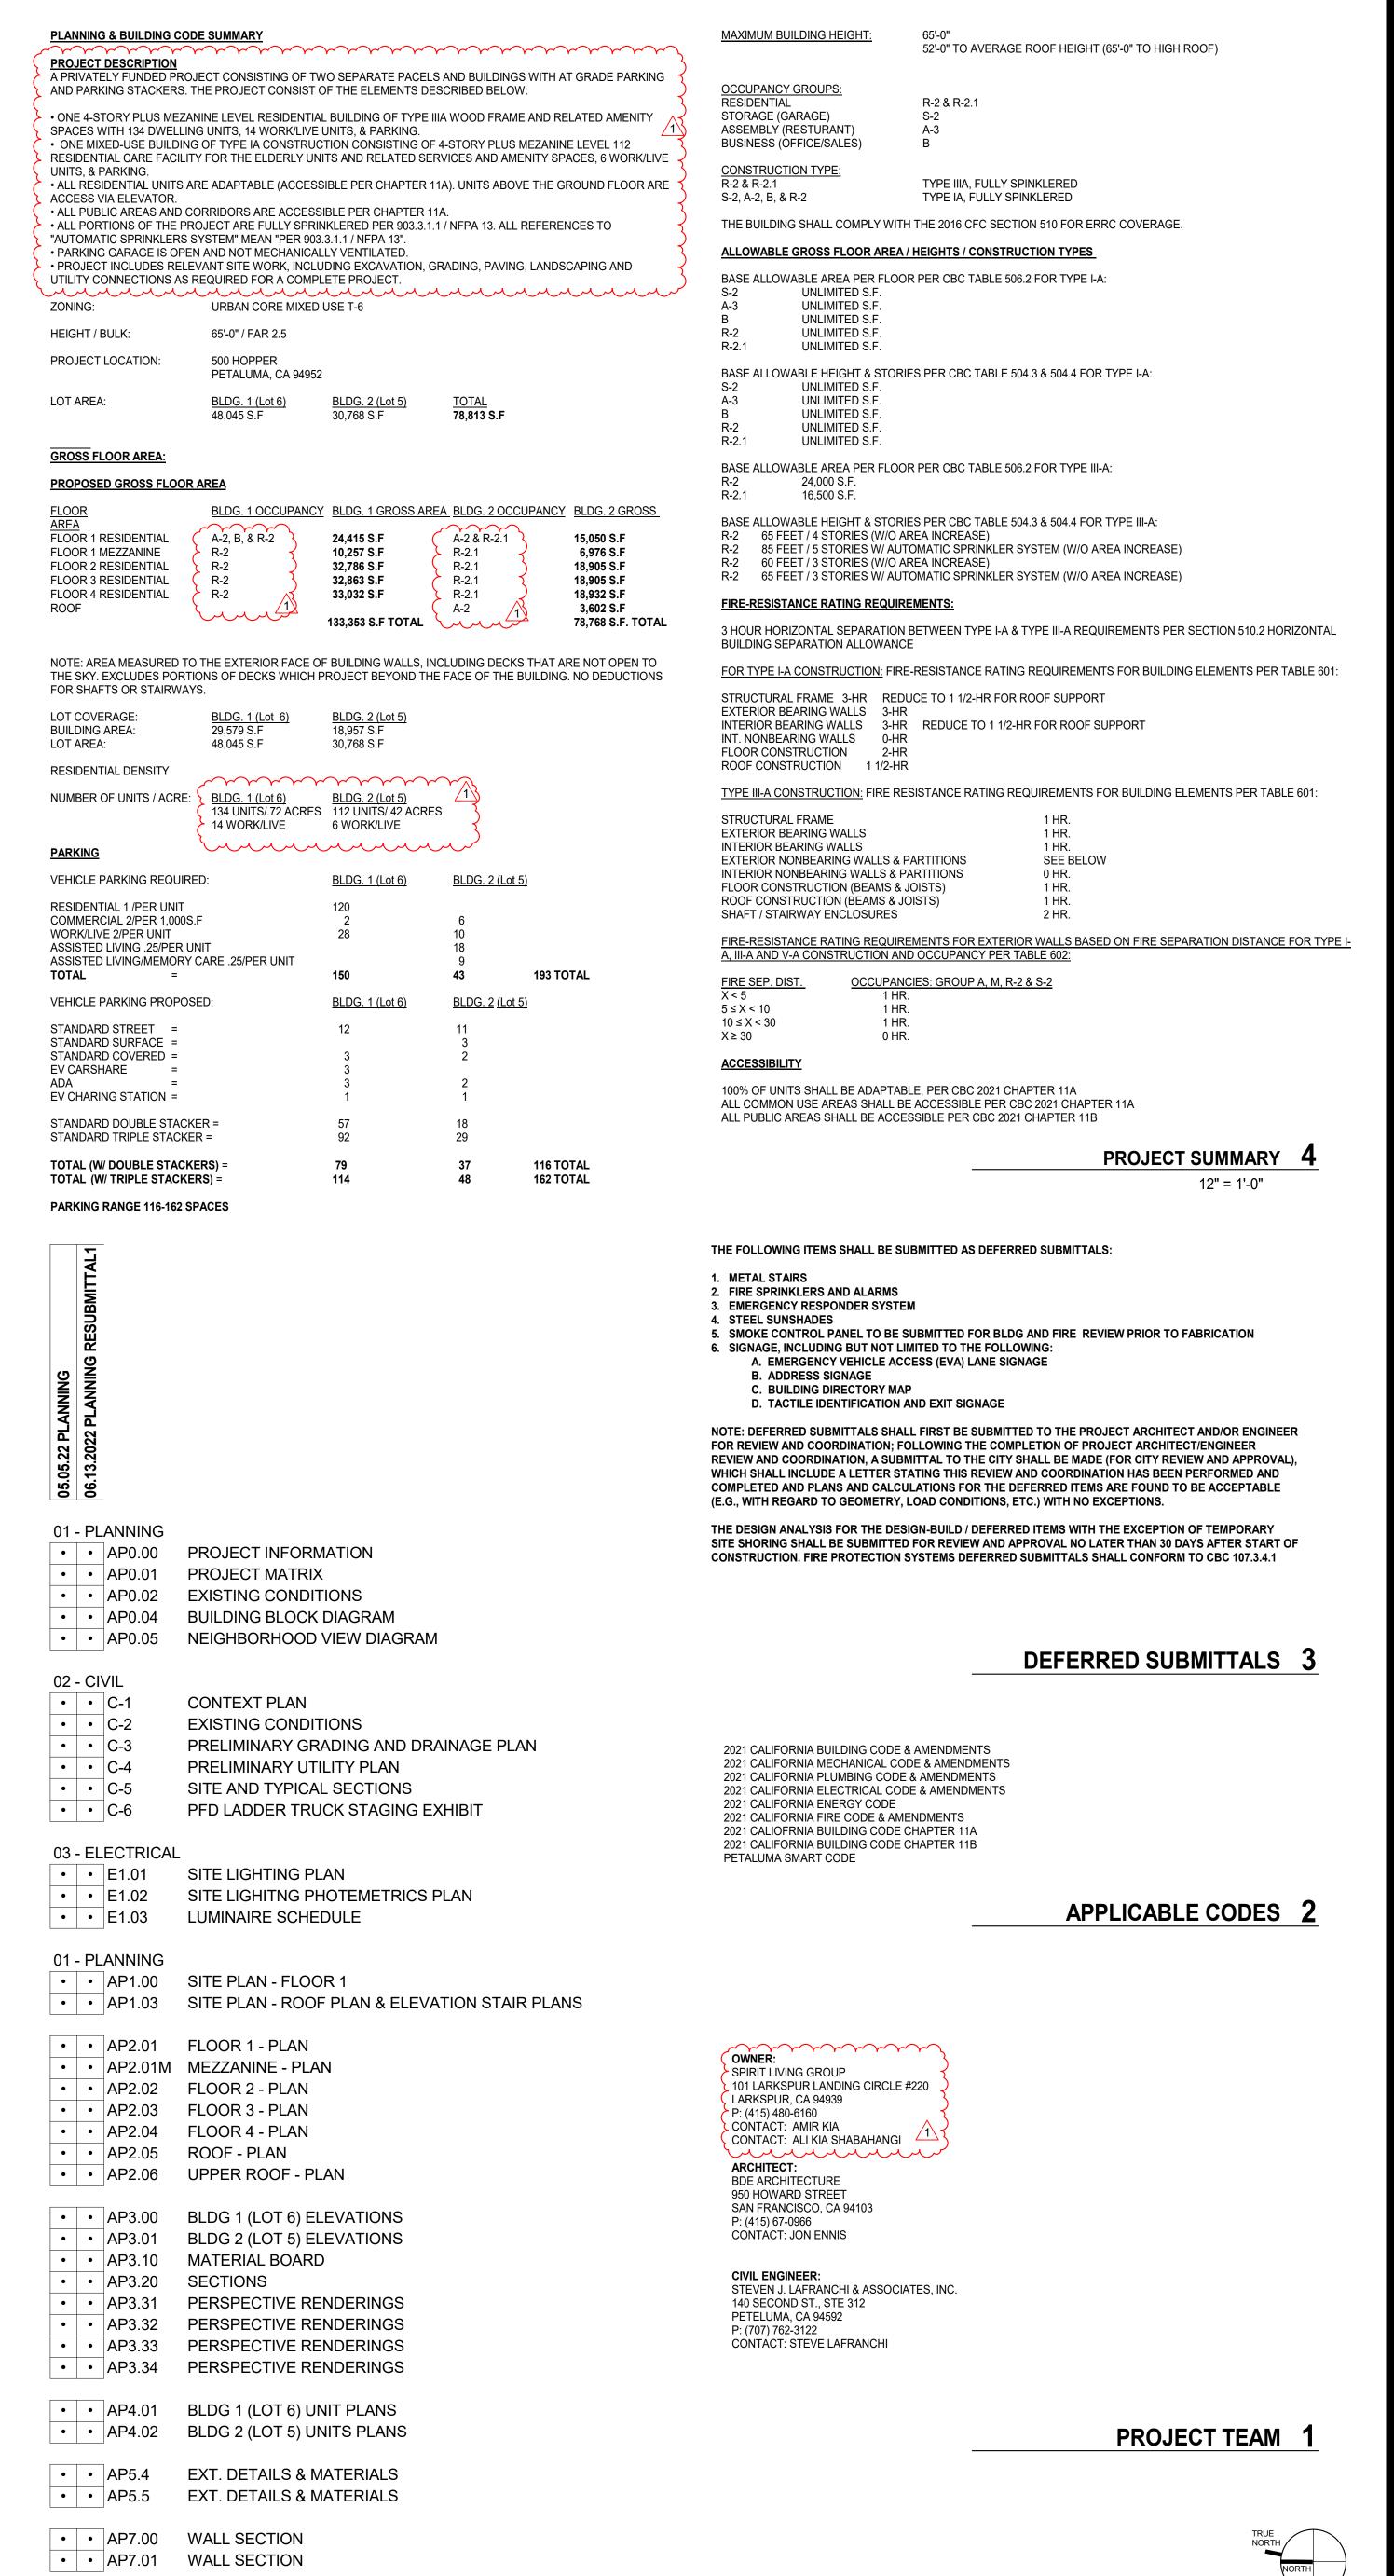

934 Howard Street San Francisco, CA

P. (415) 677-0966

CLIENT

LIVING GROUP

CONSULTANT

5

REV ISSUE

ENTITLEMEN 5.5.22

PLANNING 6.6.22

RESUBMITTA

SHEET TITLE: SCALE: As indicated PROJ #. 2110 DRAWN BY: XX

STAMP

SHEET SIZE: 30 x 42

ALL DRAWINGS AND WRITTEN MATERIAL APPEARING HEREIN CONSTITUTE ORIGINAL,

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INFORMATION

AND UNPUBLISHED WORK OF THE

PROJEC1

500 HOPPER PROJECT #: 2110 BUILDING 1 (LOT 6) UNIT AND AREA SUMMARY Revised - 06/08/2022

Crite A to de Moderno de Contenino de	f Demising; Exterior Face								1164		Daniel - A
LINUT TYPE	Unit Type	Total SQ FT	Floor Levels		OND	000	4711	Deef	Unit	%	Rentable Ar
JNIT TYPE Studio / Jr 1Br	S2.0	406	1ST	M	2ND	3RD	4TH	Roof	Total	A E0/	by Ty 2,436
STUDIO / JR TBR	\$2.0 \$3.0	406 417	-	-	2 2	2 2	2	-	6	4.5% 4.5%	
	\$3.0 \$4.0	417	-	-	1	2	2	-	6	4.5%	2,502 2,466
TOTAL UNITS	34.0	411	0	0	6	6	2 6	0	18	13.4%	7,404
Rentable Residential by floor (PP)			-		2,468 SF	2,468 SF	2,468 SF		10	13.4 /0	7,404
BEDROOM	A1.0	630	-	-	2,400 3F	2,400 3F	2,400 3F	-	33	24.6%	20,790
I BEDROOM	A2.0	625	_	-	11	11	11 /	<u>-</u>	12	9.0%	7,500
	A3.0	631	_	-	4	4	4	<u>-</u>	12	9.0%	7,500 7,572
	A4.0	625	_	_	2	2	2	<u>-</u>	6	4.5%	3,750
	A5.0	548	_	-	1	1	1	-	3	2.2%	1,644
	A6.0	458	_	-	1	1	1	-	3	2.2%	1,374
	A7.0	433	_	-	1	1	1	-	3	2.2%	1,299
TOTAL UNITS	A7.0	433	0	0	24	24	24	0	72	53.7%	43,929
Rentable Residential by floor (PP)			-	-	14,643 SF	14,643 SF	14,643 SF	-	12	33.1 /0	45,323
BEDROOM	B1.0	944	-	-	2	14,043 31	14,043 31		6	4.5%	5,664
BEDITOON	B2.0	916		_	1	1	1	<u>-</u>	12	9.0%	10,992
	B3.0	891	_	_	2	2	2	<u>-</u>	6	4.5%	5,346
	B4.0	1280	_	-		2	2	-	6	4.5%	7,680
TOTAL UNITS	D4.U	1200	0	0	2 10	10	10	0	30	22.4%	29,682
Rentable Residential by floor (PP)			-	_	9,894 SF	9,894 SF	9,894 SF	U 	30	44.4/0	23,002
VORK LIVE	WL1.0	768	1	-		3,034 SF		-	1	0.7%	1 040
YOKK LIVE	WL1.0 WL1.0-M	700 272	'	-	-	-	-	-	'	0.7%	1,040
	WL1.0-M WL1.1	783	2						2	1 50/	0 440
	WL1.1 WL1.1-M	763 272	2	-	-	_	-	-	2	1.5%	2,110
		799	4							0.70/	4.000
	WL1.2	269	1	-	-	-	-	-	1	0.7%	1,068
	WL1.2-M	269 1034	4							0.70/	4 440
	WL2.0	408	1	-	-	-	-	-	1	0.7%	1,442
	WL2.0-M		7						7	5.00/	0.000
	WL3.0	980	/	-	-	-	-	-	7	5.2%	9,688
	WL3.0-M	404								4.50/	0.500
	WL4.0	999 755	2	-	-	-	-	-	2	1.5%	3,508
TOTAL UNITS	WL4.0-M	755	14	0	0	0	0	0	14	10.4%	18,856
Rentable Residential by floor (PP)			13,025 SF	5,831 SF	-	_	-	-	14	10.4 /0	10,030
TOTAL UNITS				0,001 01				0	134	100%	99.871
			14		40	40	40		134	100%	99,871
TOTAL UNITS Avg. Unit Size									134	100%	99,871
Avg. Unit Size									99,871 SF	100%	·
Avg. Unit Size Rentable Residential by floor (PP)			14	0	40	40	40	0		100%	99,871
Avg. Unit Size Rentable Residential by floor (PP) Bike Room			13,025 SF 312 SF	5,831 SF	40 27,005 SF	40 27,005 SF	40	0		100%	99,871 312
Avg. Unit Size Rentable Residential by floor (PP) Bike Room BOH			13,025 SF 312 SF 1,190 SF	5,831 SF	27,005 SF	40 27,005 SF	27,005 SF	0		100%	99,871 312 1,190
Avg. Unit Size Rentable Residential by floor (PP) Bike Room BOH Vertical Circulation			13,025 SF 312 SF 1,190 SF 640 SF	5,831 SF - -	40 27,005 SF	27,005 SF	40	0		100%	99,871 312 1,190 2,757
Avg. Unit Size Rentable Residential by floor (PP) Bike Room BOH Vertical Circulation Club Room			13,025 SF 312 SF 1,190 SF	5,831 SF - - 454 SF	27,005 SF	27,005 SF	27,005 SF	0		100%	99,871 312 1,190 2,757 3,528
Avg. Unit Size Rentable Residential by floor (PP) Bike Room BOH Vertical Circulation Club Room Corridor			13,025 SF 312 SF 1,190 SF 640 SF 3,528 SF	5,831 SF - - - 454 SF -	27,005 SF - 503 SF -	27,005 SF - 580 SF -	27,005 SF - 580 SF -	0		100%	99,871 312 1,190 2,757 3,528 7,085
Avg. Unit Size Rentable Residential by floor (PP) Bike Room BOH Vertical Circulation Club Room Corridor Fitness			13,025 SF 312 SF 1,190 SF 640 SF 3,528 SF	5,831 SF - - 454 SF - - 1,797 SF	27,005 SF - 503 SF -	27,005 SF - 580 SF -	27,005 SF - 580 SF -	0		100%	99,871 312 1,190 2,757 3,528 7,085 1,797
Rentable Residential by floor (PP) Bike Room BOH Vertical Circulation Club Room Corridor Fitness Coworking			13,025 SF 312 SF 312 SF 1,190 SF 640 SF 3,528 SF 182 SF	5,831 SF - - - 454 SF - -	27,005 SF - 503 SF -	27,005 SF - 580 SF -	27,005 SF - 580 SF -	0		100%	99,871 312 1,190 2,757 3,528 7,085 1,797 1,768
Rentable Residential by floor (PP) Bike Room BOH Vertical Circulation Club Room Corridor Fitness Coworking Public Easement			13,025 SF 312 SF 1,190 SF 640 SF 3,528 SF 182 SF	5,831 SF 454 SF 1,797 SF 1,768 SF	27,005 SF - 503 SF - 2,301 SF	27,005 SF - 580 SF -	27,005 SF - 580 SF -	0		100%	99,871 312 1,190 2,757 3,528 7,085 1,797 1,768 1,483
Rentable Residential by floor (PP) Bike Room BOH Vertical Circulation Club Room Corridor Fitness Coworking Public Easement Reception			13,025 SF 312 SF 1,190 SF 640 SF 3,528 SF 182 SF 1,483 SF 249 SF	5,831 SF 454 SF 1,797 SF 1,768 SF	27,005 SF - 503 SF - 2,301 SF	27,005 SF - 580 SF -	27,005 SF - 580 SF -	0		100%	99,871 312 1,190 2,757 3,528 7,085 1,797 1,768 1,483 656
Rentable Residential by floor (PP) Bike Room BOH Vertical Circulation Club Room Corridor Fitness Coworking Public Easement Reception Flex Space			13,025 SF 312 SF 1,190 SF 640 SF 3,528 SF 182 SF 1,483 SF 249 SF 1,079 SF	5,831 SF 454 SF - 1,797 SF 1,768 SF - 407 SF	27,005 SF - 503 SF - 2,301 SF	27,005 SF - 580 SF -	27,005 SF - 580 SF - 2,301 SF	0		100%	99,871 312 1,190 2,757 3,528 7,085 1,797 1,768 1,483 656 1,079
Rentable Residential by floor (PP) Bike Room BOH Vertical Circulation Club Room Corridor Fitness Coworking Public Easement Reception Flex Space Mail			13,025 SF 312 SF 1,190 SF 640 SF 3,528 SF 182 SF 1,483 SF 249 SF	5,831 SF - 454 SF - 1,797 SF 1,768 SF - 407 SF	27,005 SF - 503 SF - 2,301 SF	27,005 SF - 580 SF - 2,301 SF	27,005 SF - 580 SF - 2,301 SF	0		100%	99,871 312 1,190 2,757 3,528 7,085 1,797 1,768 1,483 656 1,079 345
Rentable Residential by floor (PP) Bike Room BOH Vertical Circulation Club Room Corridor Fitness Coworking Public Easement Reception Flex Space Mail DF			13,025 SF 312 SF 1,190 SF 640 SF 3,528 SF 182 SF 1,483 SF 249 SF 1,079 SF 345 SF	5,831 SF - 454 SF - 1,797 SF 1,768 SF - 407 SF	27,005 SF - 503 SF - 2,301 SF 60 SF	27,005 SF - 580 SF - 2,301 SF 60 SF	27,005 SF - 580 SF - 2,301 SF 60 SF	0		100%	99,871 312 1,190 2,757 3,528 7,085 1,797 1,768 1,483 656 1,079 345
Rentable Residential by floor (PP) Bike Room BOH Vertical Circulation Club Room Corridor Fitness Coworking Public Easement Reception Flex Space Mail DF Trash			13,025 SF 312 SF 1,190 SF 640 SF 3,528 SF 182 SF 1,483 SF 249 SF 1,079 SF 345 SF	5,831 SF 454 SF - 1,797 SF 1,768 SF - 407 SF	27,005 SF - 503 SF - 2,301 SF	27,005 SF - 580 SF - 2,301 SF	27,005 SF - 580 SF - 2,301 SF	0		100%	99,871 312 1,190 2,757 3,528 7,085 1,797 1,768 1,483 656 1,079 345 180 715
Rentable Residential by floor (PP) Bike Room BOH Vertical Circulation Club Room Corridor Fitness Coworking Public Easement Reception Flex Space Mail DF Trash Restroom			13,025 SF 312 SF 312 SF 1,190 SF 640 SF 3,528 SF 182 SF 1,483 SF 249 SF 1,079 SF 345 SF 379 SF 252 SF	5,831 SF 454 SF - 1,797 SF 1,768 SF - 407 SF	27,005 SF - 503 SF - 2,301 SF 60 SF 112 SF	27,005 SF - 580 SF - 2,301 SF 60 SF	27,005 SF - 580 SF - 2,301 SF 60 SF	0		100%	99,871 312 1,190 2,757 3,528 7,085 1,797 1,768 1,483 656 1,079 345 180 715 252
Rentable Residential by floor (PP) Bike Room BOH Vertical Circulation Club Room Corridor Fitness Coworking Public Easement Reception Flex Space Mail DF Frash Restroom Lobby			13,025 SF 312 SF 312 SF 1,190 SF 640 SF 3,528 SF 182 SF 1,483 SF 249 SF 1,079 SF 345 SF 379 SF 252 SF 1,090 SF	5,831 SF 454 SF - 1,797 SF 1,768 SF - 407 SF	27,005 SF - 503 SF - 2,301 SF 60 SF 112 SF -	27,005 SF - 580 SF - 2,301 SF 60 SF 112 SF -	27,005 SF - 580 SF - 2,301 SF - 60 SF 112 SF	0		100%	99,871 312 1,190 2,757 3,528 7,085 1,797 1,768 1,483 656 1,079 345 180 715 252 1,090
Rentable Residential by floor (PP) Bike Room BOH Vertical Circulation Club Room Corridor Fitness Coworking Public Easement Reception Flex Space Mail DF Frash Restroom Lobby			13,025 SF 312 SF 312 SF 1,190 SF 640 SF 3,528 SF 182 SF 1,483 SF 249 SF 1,079 SF 345 SF 379 SF 252 SF	5,831 SF 454 SF - 1,797 SF 1,768 SF - 407 SF	27,005 SF - 503 SF - 2,301 SF 60 SF 112 SF	27,005 SF - 580 SF - 2,301 SF 60 SF	27,005 SF - 580 SF - 2,301 SF 60 SF	0		100%	99,871 312 1,190 2,757 3,528 7,085 1,797 1,768 1,483 656 1,079 345 180 715 252 1,090
Rentable Residential by floor (PP) Bike Room BOH Vertical Circulation Club Room Corridor Fitness Coworking Public Easement Reception Flex Space Mail DF Frash Restroom Lobby Parking Bross Building Gross Building (Measur	ed from exterior face of		13,025 SF 312 SF 312 SF 1,190 SF 640 SF 3,528 SF 182 SF 1,483 SF 249 SF 1,079 SF 345 SF 379 SF 252 SF 1,090 SF	5,831 SF 454 SF - 1,797 SF 1,768 SF - 407 SF	27,005 SF - 503 SF - 2,301 SF 60 SF 112 SF -	27,005 SF - 580 SF - 2,301 SF 60 SF 112 SF -	27,005 SF - 580 SF - 2,301 SF - 60 SF 112 SF	0		100%	99,871 312 1,190 2,757 3,528 7,085 1,797 1,768 1,483 656 1,079 345 180 715 252 1,090
Rentable Residential by floor (PP) Bike Room BOH Vertical Circulation Club Room Corridor Fitness Coworking Public Easement Reception Flex Space Mail DF Trash Restroom Lobby Parking Gross Building Ext wall, Including, unit decks, shaft	s, stairs and elevators.		13,025 SF 312 SF 1,190 SF 640 SF 3,528 SF 182 SF 1,483 SF 249 SF 1,079 SF 345 SF 379 SF 252 SF 1,090 SF 9,577 SF	5,831 SF 454 SF - 1,797 SF 1,768 SF - 407 SF	27,005 SF - 503 SF - 2,301 SF - 60 SF 112 SF	27,005 SF - 580 SF - 2,301 SF - 60 SF 112 SF	27,005 SF - 580 SF - 2,301 SF - 60 SF 112 SF	0		100%	99,871 312 1,190 2,757 3,528 7,085 1,797 1,768 1,483 656 1,079 345 180 715 252 1,090 9,577
Rentable Residential by floor (PP) Bike Room BOH Vertical Circulation Club Room Corridor Fitness Coworking Public Easement Reception Flex Space Mail DF Trash Restroom Lobby Parking Gross Building Ext wall, Including, unit decks, shafts Not including roof, roof deck or podi	s, stairs and elevators. um decks, not including		13,025 SF 312 SF 312 SF 1,190 SF 640 SF 3,528 SF 182 SF 1,483 SF 249 SF 1,079 SF 345 SF 379 SF 252 SF 1,090 SF	5,831 SF 454 SF - 1,797 SF 1,768 SF - 407 SF	27,005 SF - 503 SF - 2,301 SF 60 SF 112 SF -	27,005 SF - 580 SF - 2,301 SF 60 SF 112 SF -	27,005 SF - 580 SF - 2,301 SF - 60 SF 112 SF	0		100%	99,871 312 1,190 2,757 3,528 7,085 1,797 1,768 1,483 656 1,079 345 180 715 252 1,090 9,577
Rentable Residential by floor (PP) Bike Room BOH Vertical Circulation Club Room Corridor Fitness Coworking Public Easement Reception Flex Space Mail DF Trash Restroom Lobby Parking Gross Building (Measurext wall, Including, unit decks, shaft and including roof, roof deck or poding area above first level at double height	s, stairs and elevators. ium decks, not including ht space, not including		13,025 SF 312 SF 1,190 SF 640 SF 3,528 SF 182 SF 1,483 SF 249 SF 1,079 SF 345 SF 379 SF 252 SF 1,090 SF 9,577 SF	5,831 SF 454 SF - 1,797 SF 1,768 SF - 407 SF	27,005 SF - 503 SF - 2,301 SF - 60 SF 112 SF	27,005 SF - 580 SF - 2,301 SF - 60 SF 112 SF	27,005 SF - 580 SF - 2,301 SF - 60 SF 112 SF	0		100%	99,871 312 1,190 2,757 3,528 7,085 1,797 1,768 1,483 656 1,079 345 180 715 252 1,090 9,577
Rentable Residential by floor (PP) Bike Room BOH Vertical Circulation Club Room Corridor Fitness Coworking Public Easement Reception Flex Space Mail DF Frash Restroom Lobby Parking Gross Building (Measurext wall, Including, unit decks, shaft working) For the sext wall, Including, unit decks or podicarea above first level at double heigh parking/garage, Assumes 7'-0" corri	s, stairs and elevators. ium decks, not including ht space, not including		13,025 SF 312 SF 1,190 SF 640 SF 3,528 SF 182 SF 1,483 SF 249 SF 1,079 SF 345 SF 379 SF 252 SF 1,090 SF 9,577 SF	5,831 SF 454 SF - 1,797 SF 1,768 SF - 407 SF	27,005 SF - 503 SF - 2,301 SF 60 SF 112 SF 32,786	27,005 SF - 580 SF - 2,301 SF 60 SF 112 SF	27,005 SF - 580 SF - 2,301 SF - 60 SF 112 SF - 33,032	0		100%	99,871 312 1,190 2,757 3,528 7,085 1,797 1,768 1,483 656 1,079 345 180 715 252 1,090 9,577
Rentable Residential by floor (PP) Bike Room BOH Vertical Circulation Club Room Corridor Fitness Coworking Public Easement Reception Flex Space Mail DF Trash Restroom Lobby Parking Bross Building (Measurext wall, Including, unit decks, shaft wall, Including, unit decks, shaft wall, Including roof, roof deck or poding area above first level at double heig barking/garage, Assumes 7'-0" corri	s, stairs and elevators. ium decks, not including ht space, not including		13,025 SF 312 SF 1,190 SF 640 SF 3,528 SF 182 SF 1,483 SF 249 SF 1,079 SF 345 SF 379 SF 252 SF 1,090 SF 9,577 SF	5,831 SF 454 SF - 1,797 SF 1,768 SF - 407 SF	27,005 SF - 503 SF - 2,301 SF - 60 SF 112 SF	27,005 SF - 580 SF - 2,301 SF - 60 SF 112 SF	27,005 SF - 580 SF - 2,301 SF - 60 SF 112 SF	0		100%	99,871 312 1,190 2,757 3,528 7,085 1,797 1,768 1,483 656 1,079 345 180 715 252 1,090 9,577
Rentable Residential by floor (PP) Bike Room BOH Vertical Circulation Club Room Corridor Fitness Coworking Public Easement Reception Flex Space Mail DF Frash Restroom Lobby Parking Gross Building (Measurext wall, Including, unit decks, shafts area above first level at double heig barking/garage, Assumes 7'-0" corriderest Saleable/Gross Building Landscape	s, stairs and elevators. ium decks, not including ht space, not including		13,025 SF 312 SF 1,190 SF 640 SF 3,528 SF 182 SF 1,483 SF 249 SF 1,079 SF 345 SF 379 SF 252 SF 1,090 SF 9,577 SF 23,754	5,831 SF 454 SF - 1,797 SF 1,768 SF - 407 SF	27,005 SF - 503 SF - 2,301 SF - 60 SF 112 SF 32,786	27,005 SF - 580 SF - 2,301 SF - 60 SF 112 SF 00 SF	27,005 SF - 580 SF - 2,301 SF - 60 SF 112 SF - 33,032			100%	99,871 312 1,190 2,757 3,528 7,085 1,797 1,768 1,483 656 1,079 345 180 715 252 1,090 9,577
Rentable Residential by floor (PP) Bike Room BOH Vertical Circulation Club Room Corridor Fitness Coworking Public Easement Reception Flex Space Mail DF Trash Restroom Lobby Parking	s, stairs and elevators. ium decks, not including ht space, not including		13,025 SF 312 SF 1,190 SF 640 SF 3,528 SF 182 SF 1,483 SF 249 SF 1,079 SF 345 SF 379 SF 252 SF 1,090 SF 9,577 SF	5,831 SF 454 SF - 1,797 SF 1,768 SF - 407 SF	27,005 SF - 503 SF - 2,301 SF 60 SF 112 SF 32,786	27,005 SF - 580 SF - 2,301 SF 60 SF 112 SF	27,005 SF - 580 SF - 2,301 SF - 60 SF 112 SF - 33,032	0		100%	99,871 312 1,190 2,757 3,528 7,085 1,797 1,768 1,483 656 1,079 345 180 715 252 1,090 9,577 132,692

500 HOPPER PROJECT #: 2110 BUILDING 2 (LOT 5) UNIT AND AREA SUMMARY Revised - 06/08/2022

		,						,			
UNIT TYPE	Unit Type	Total SQ FT	1ST	M	Floor 2ND	Levels 3RD	4TH	Roof	Unit Total	%	Rentable Area
TUDIO	S20.0	400	-	IVI -	2ND 6	3KD	4117	-	10tai 12	10.7%	by Type 4,800 SF
	S21.0	382	-	-	1	1	-	-	2	1.8%	764 SF
	S22.0	426	-	-	7	7	-	-	14	12.5%	5,964 SF
	S23.0	369	-	-	1	1	-	-	2	1.8%	738 SF
	S24.0	396	-	-	3	3	-	-	6	5.4%	2,376 SF
	S26.0 S27.0	434	-	-	1	1	-	-	2	1.8% 1.8%	868 SF
OTAL UNITS	527.0	463	0	0	20	20	0	0	2 40	35.7%	926 SF 16,436 SF
entable Residential by flo	oor (PP)		-	-	8,218 SF	8,218 SF	-	-	70	33.7 /0	10,430 31
BEDROOM	A20.0	520	-	-	6	6	-	-	12	10.7%	6,240 SF
	A21.0	473	-	-	1	1	-	-	2	1.8%	946 SF
	A22.0	597	-	-	3	3	-	-	6	5.4%	3,582 SF
	A23.0	544	-	-	1	1	-	-	2	1.8%	1,088 SF
OTAL LINITO	A24.0	636	-	-	1	1	-	-	2	1.8%	1,272 SF
OTAL UNITS entable Residential by flo	oor (DD)		0 -	0	12 6,564 SF	12 6,564 SF	0	0	24	21.4%	13,128 SF
BEDROOM	B20.0	726	-	-	1	0,304 31	-	-	2	1.8%	1,452 SF
	B21.0	737	-	_	1	1	_	_	2	1.8%	1,474 SF
	B22.0	905	-	-	1	1	-	-	2	1.8%	1,810 SF
OTAL UNITS			0	0	3	3	0	0	6	5.4%	4,736 SF
entable Residential by flo			-	-	2,368 SF	2,368 SF	-	-			
EMORY	MC1.0	369	-	-	-	-	18		18		6,642 SF
ARE	MC2.0	406	-	-	-	-	5	-	5	4.5%	2,030 SF
	MC3.0	373 345	-	-	-	-	0	-	6	5.4% 1.8%	2,238 SF 690 SF
	MC4.0 MC5.0	434		_	- -	_	1		2	0.9%	690 SF 434 SF
	MC5.0 MC6.0	490	-		-		1		1	0.9%	434 SF 490 SF
	MC7.0	595	-	_	-	_	1	_	1	0.9%	595 SF
	MC8.0	474	-	_	-	_	1	_	1	0.9%	474 SF
	MC9.0	457	-	-	-	-	1	-	1	0.9%	457 SF
OTAL UNITS			0	0	0	0	36	0	36	32.1%	14,050 SF
entable Residential by flo	oor (PP)		-	-	-	-	14,050 SF	-			
ORK LIVE	WL6.0	806		1	-	_	_	_	1	0.9%	1,672 SF
	***20.0	866		'					•	0.070	1,072 01
	WL7.0	799		1	-	_	_	_	1	0.9%	1,349 SF
		550									,
	WL8.0	900		1	-	-	-	_	1	0.9%	1,696 SF
		796							-		,
	WL9.0	867		1	-	_	_	_	1	16.7%	1,427 SF
		560							-		, =: =:
	WL10.0	963		2	-	-	_	-	2	1.8%	3,046 SF
OTAL UNITS		560		6	0	0	0	0	6	5.4%	9,190 SF
entable Residential by flo	oor (PP)			00 SF	- -	-	_	-	U	J.4 70	ਹ, 130 ਹ ਿ
OTAL UNITS	\ /			6	35	35	36	0	112	100%	57,540 SF
vg. Unit Size											
entable Residential by flo	oor (PP)	I	4,431 SF	4,759 SF	17,150 SF	17,150 SF	14,050 SF				57,540 SF
entable Residential by flo ike Room	טו (רר)		4,431 SF 353 SF	4,759 SF	17,100 SF	17,150 SF	14,000 SF	-			57,540 SF 353 SF
OH			934 SF	-	<u>-</u>	-	-	-			934 SF
ertical Circulation			573 SF	231 SF	680 SF	680 SF	680 SF	369 SF			3,213 SF
ublic Easement			1,051 SF	-	-	-	-	-			1,051 SF
ervice Corridor/Corridor			507 SF	-	1,627 SF	1,627 SF	1,731 SF	1,427 SF			6,919 SF
obby			982 SF	-	-	-	-	-			982 SF
eception/Mail			197 SF								197 SF
ounge							532 SF	453 SF			985 SF
ctivites			4 770 05				781 SF				781 SF
ommunity Lounge tchen			1,776 SF 877 SF				372 SF				1,776 SF 1,249 SF
tcnen aff/Admin			877 SF 389 SF	473 SF			312 35				1,249 SF 862 SF
nenity			000 OI	77001				1,865 SF			1,865 SF
estroom			255 SF					.,555 51			255 SF
stro/Bar			762 SF								762 SF
ezzanine				2,542 SF							2,542 SF
ning							1,466 SF				1,466 SF
estaurant			1,995 SF					-			1,995 SF
F/Utility			,		128 SF	128 SF		64 SF			320 SF
ash			181 SF					-		T	181 SF
undry			262 SF	200.05							262 SF
ommercial			806 SF	393 SF							1,199 SF
arking	(Measured from exterio	r face of out well	2,980 SF	-	-	-	-	-			2,980 SF
ross Building cluding, unit decks, shaft eck or podium decks, not	ts, stairs and elevators.	Not including roof, roof									
pace, not including parkin			15,758	8,167	18,905	18,905	18,932	3,809			80,667 SF
et Saleable/Gross			0.281	0.583	0.907	0.907	0.742				
uilding			U.ZO I	0.565	0.807	0.807	U.142				
andscape											Landsc. Totals
rivate Courts			-	-	-	-	-	-			
ommon Courtyard			-	-	<u>-</u>	-	-	- 1,865 SF			4 005 05
			-	-	-	-	-	1,000 5F			1,865 SF
of-Deck		-		-						'	

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ENTITLEMEN 5.5.22 PLANNING 6.6.22 RESUBMITTA L 1


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PROJ#. 2110 DRAWN BAUTHOR SHEET SIZE: 30 x 42



AERIAL VIEW KEY 9



EXISTING SITE CONDITION 8 12" = 1'-0"

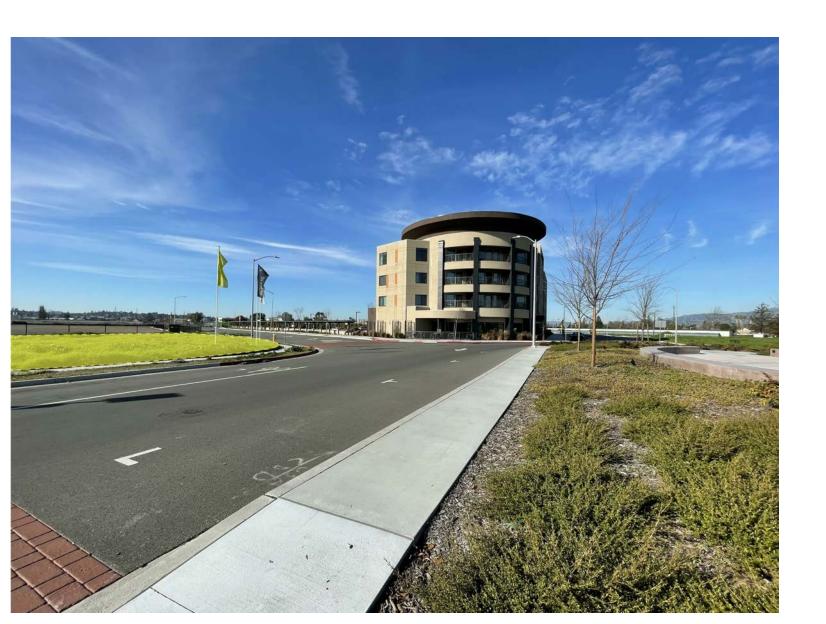

EXISTING SITE CONDITION 4


12" = 1'-0"

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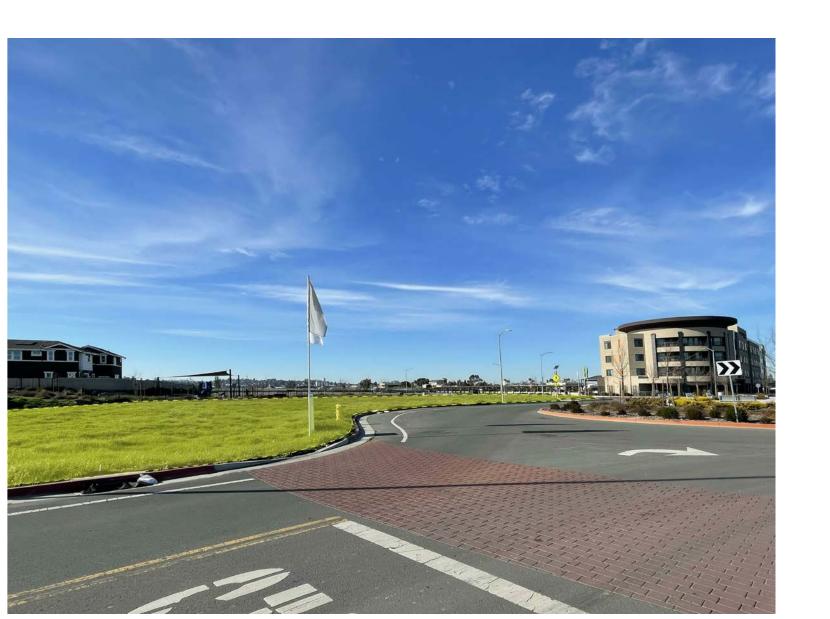
Spirit LIVING GROUP




EXISTING SITE CONDITION 7 12" = 1'-0"

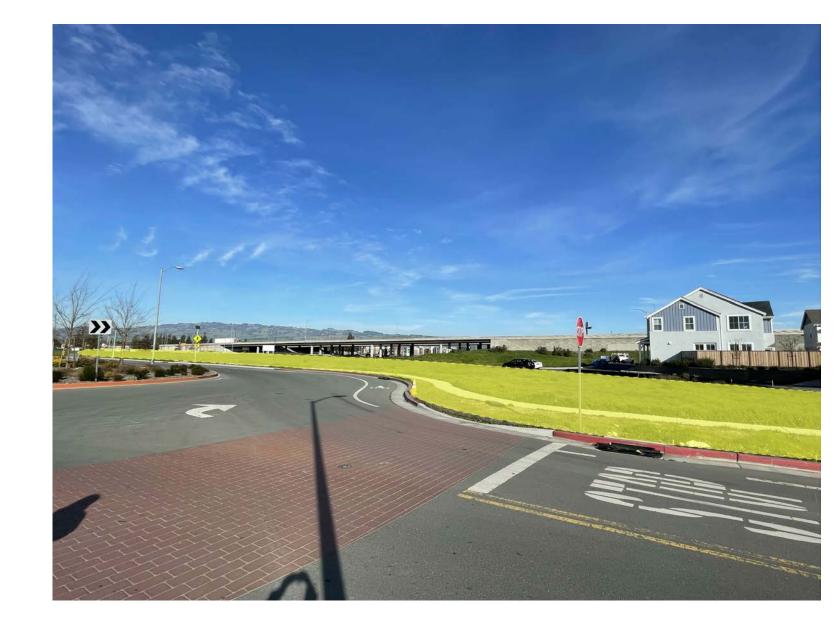


EXISTING SITE CONDITION 3 12" = 1'-0"



EXISTING SITE CONDITION 6 12" = 1'-0"

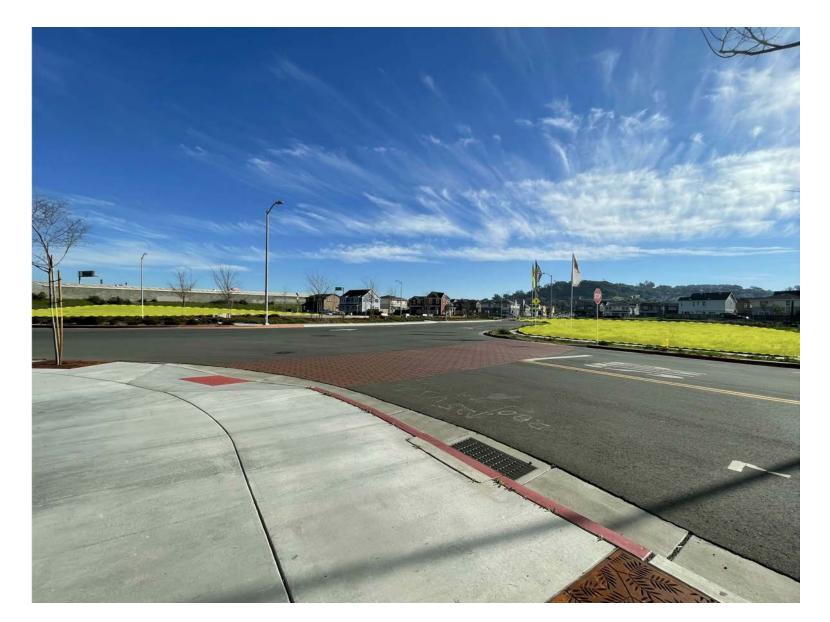

EXISTING SITE CONDITION 2

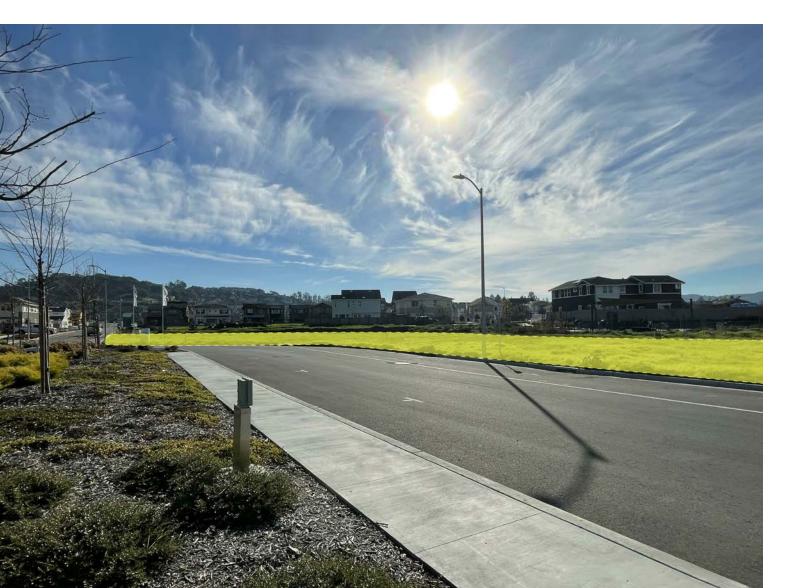

EXISTING SITE CONDITION 5 12" = 1'-0"



EXISTING SITE CONDITION 1

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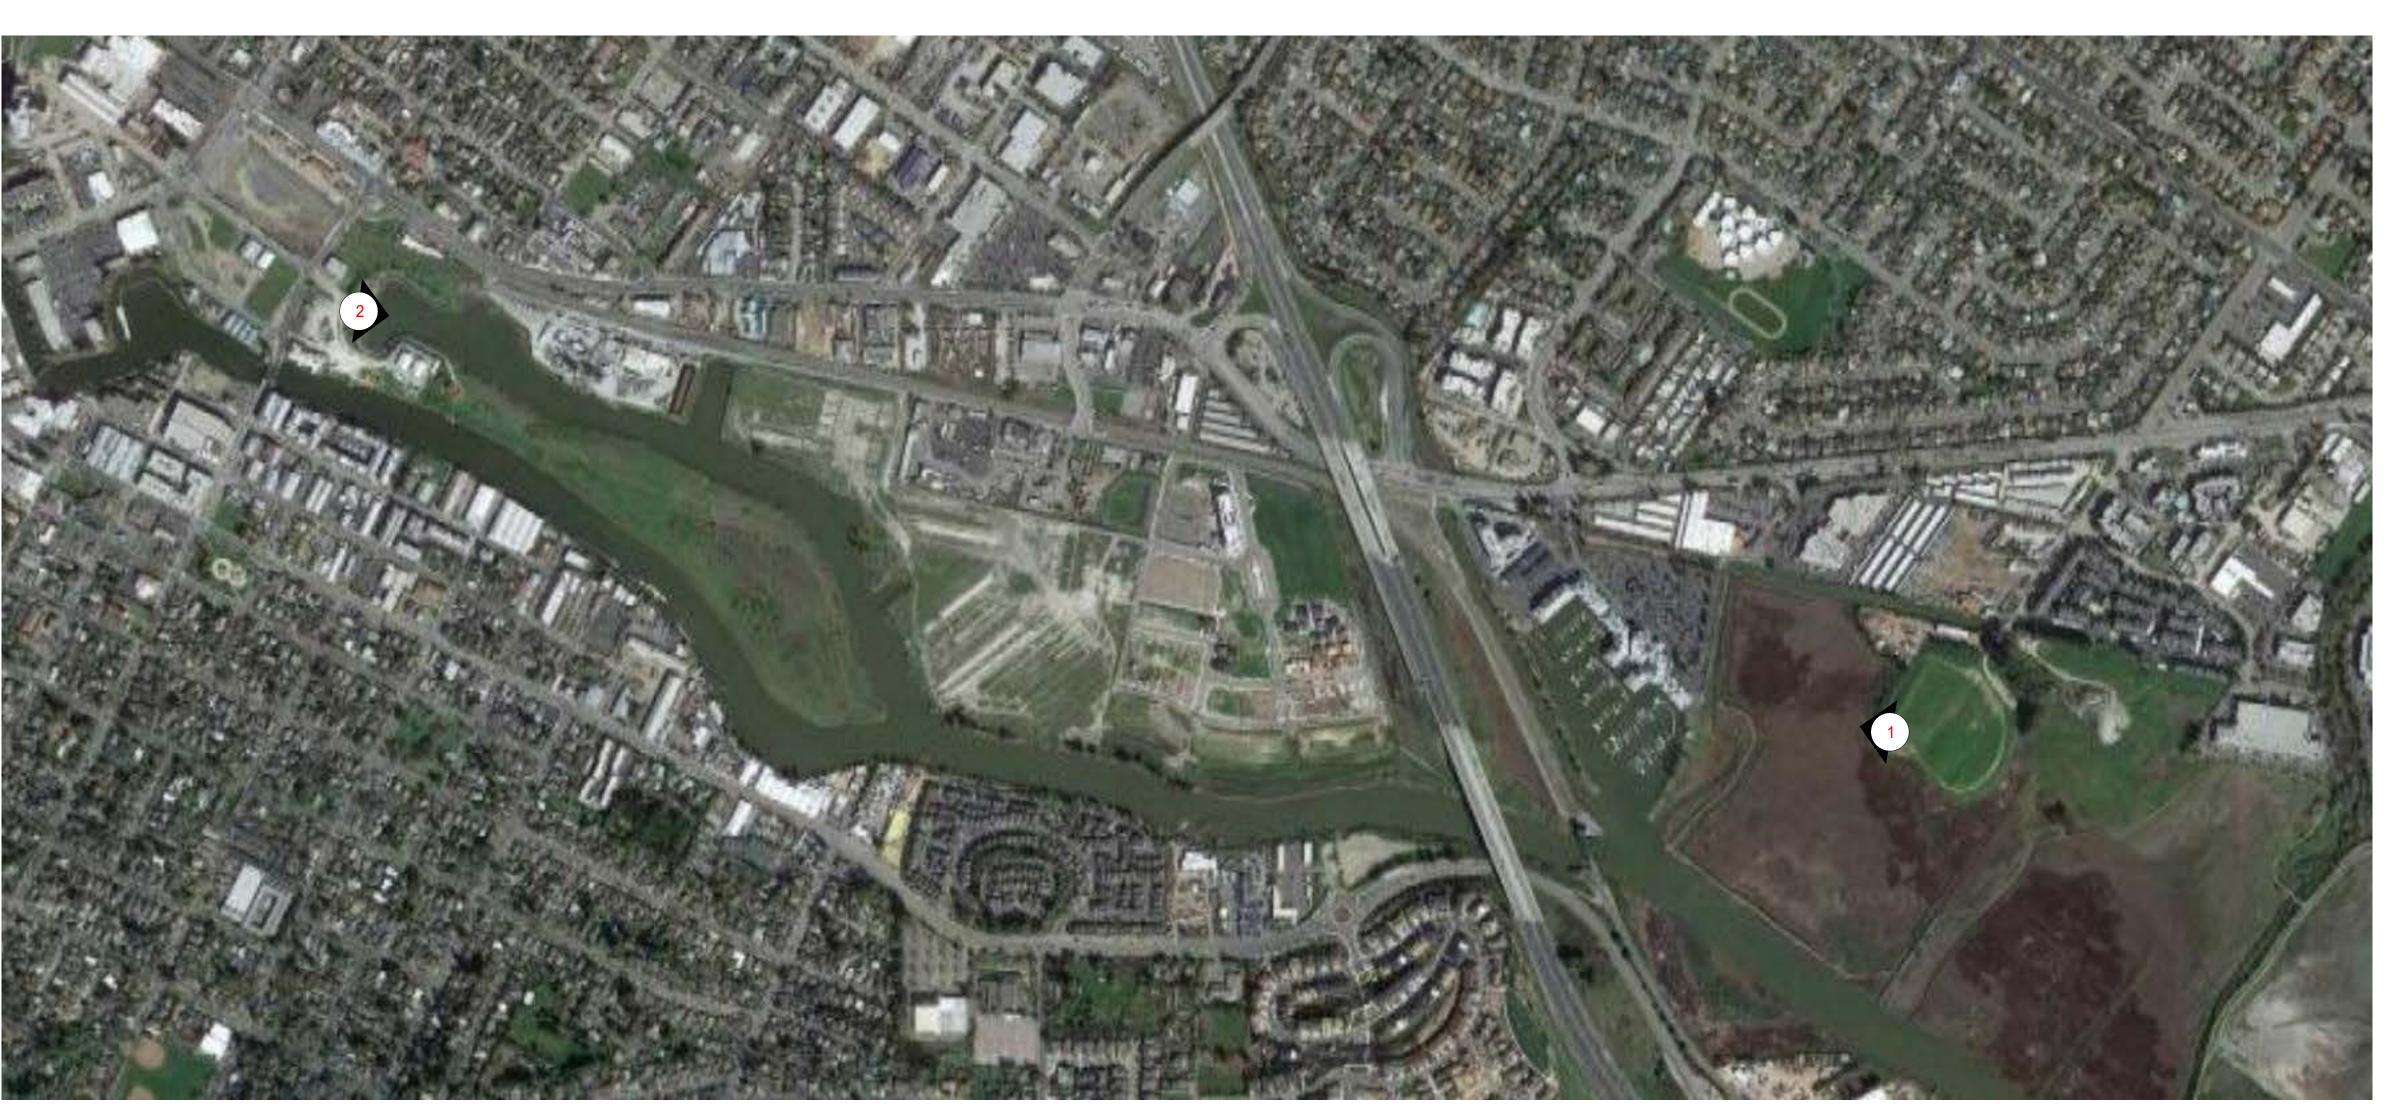
PLANNING 6.6.22 RESUBMITTA L 1

SCALE: 12" = 1'-0" PROJ#. 2110 DRAWN BAUTHOR

SHEET SIZE: 30 x 42

CONDITIONS

AP0.02



VIEW SHED KEY





VIEW SHED - MCNEAR PARK 2 1 1/2" = 1'-0"

VIEW SHED - ROCKY MOUNTIAN DOG PARK 1

1 1/2" = 1'-0"

scale: As indicated PROJ #. 2110 DRAWN BAUTHOR
SHEET SIZE: 30 X 42

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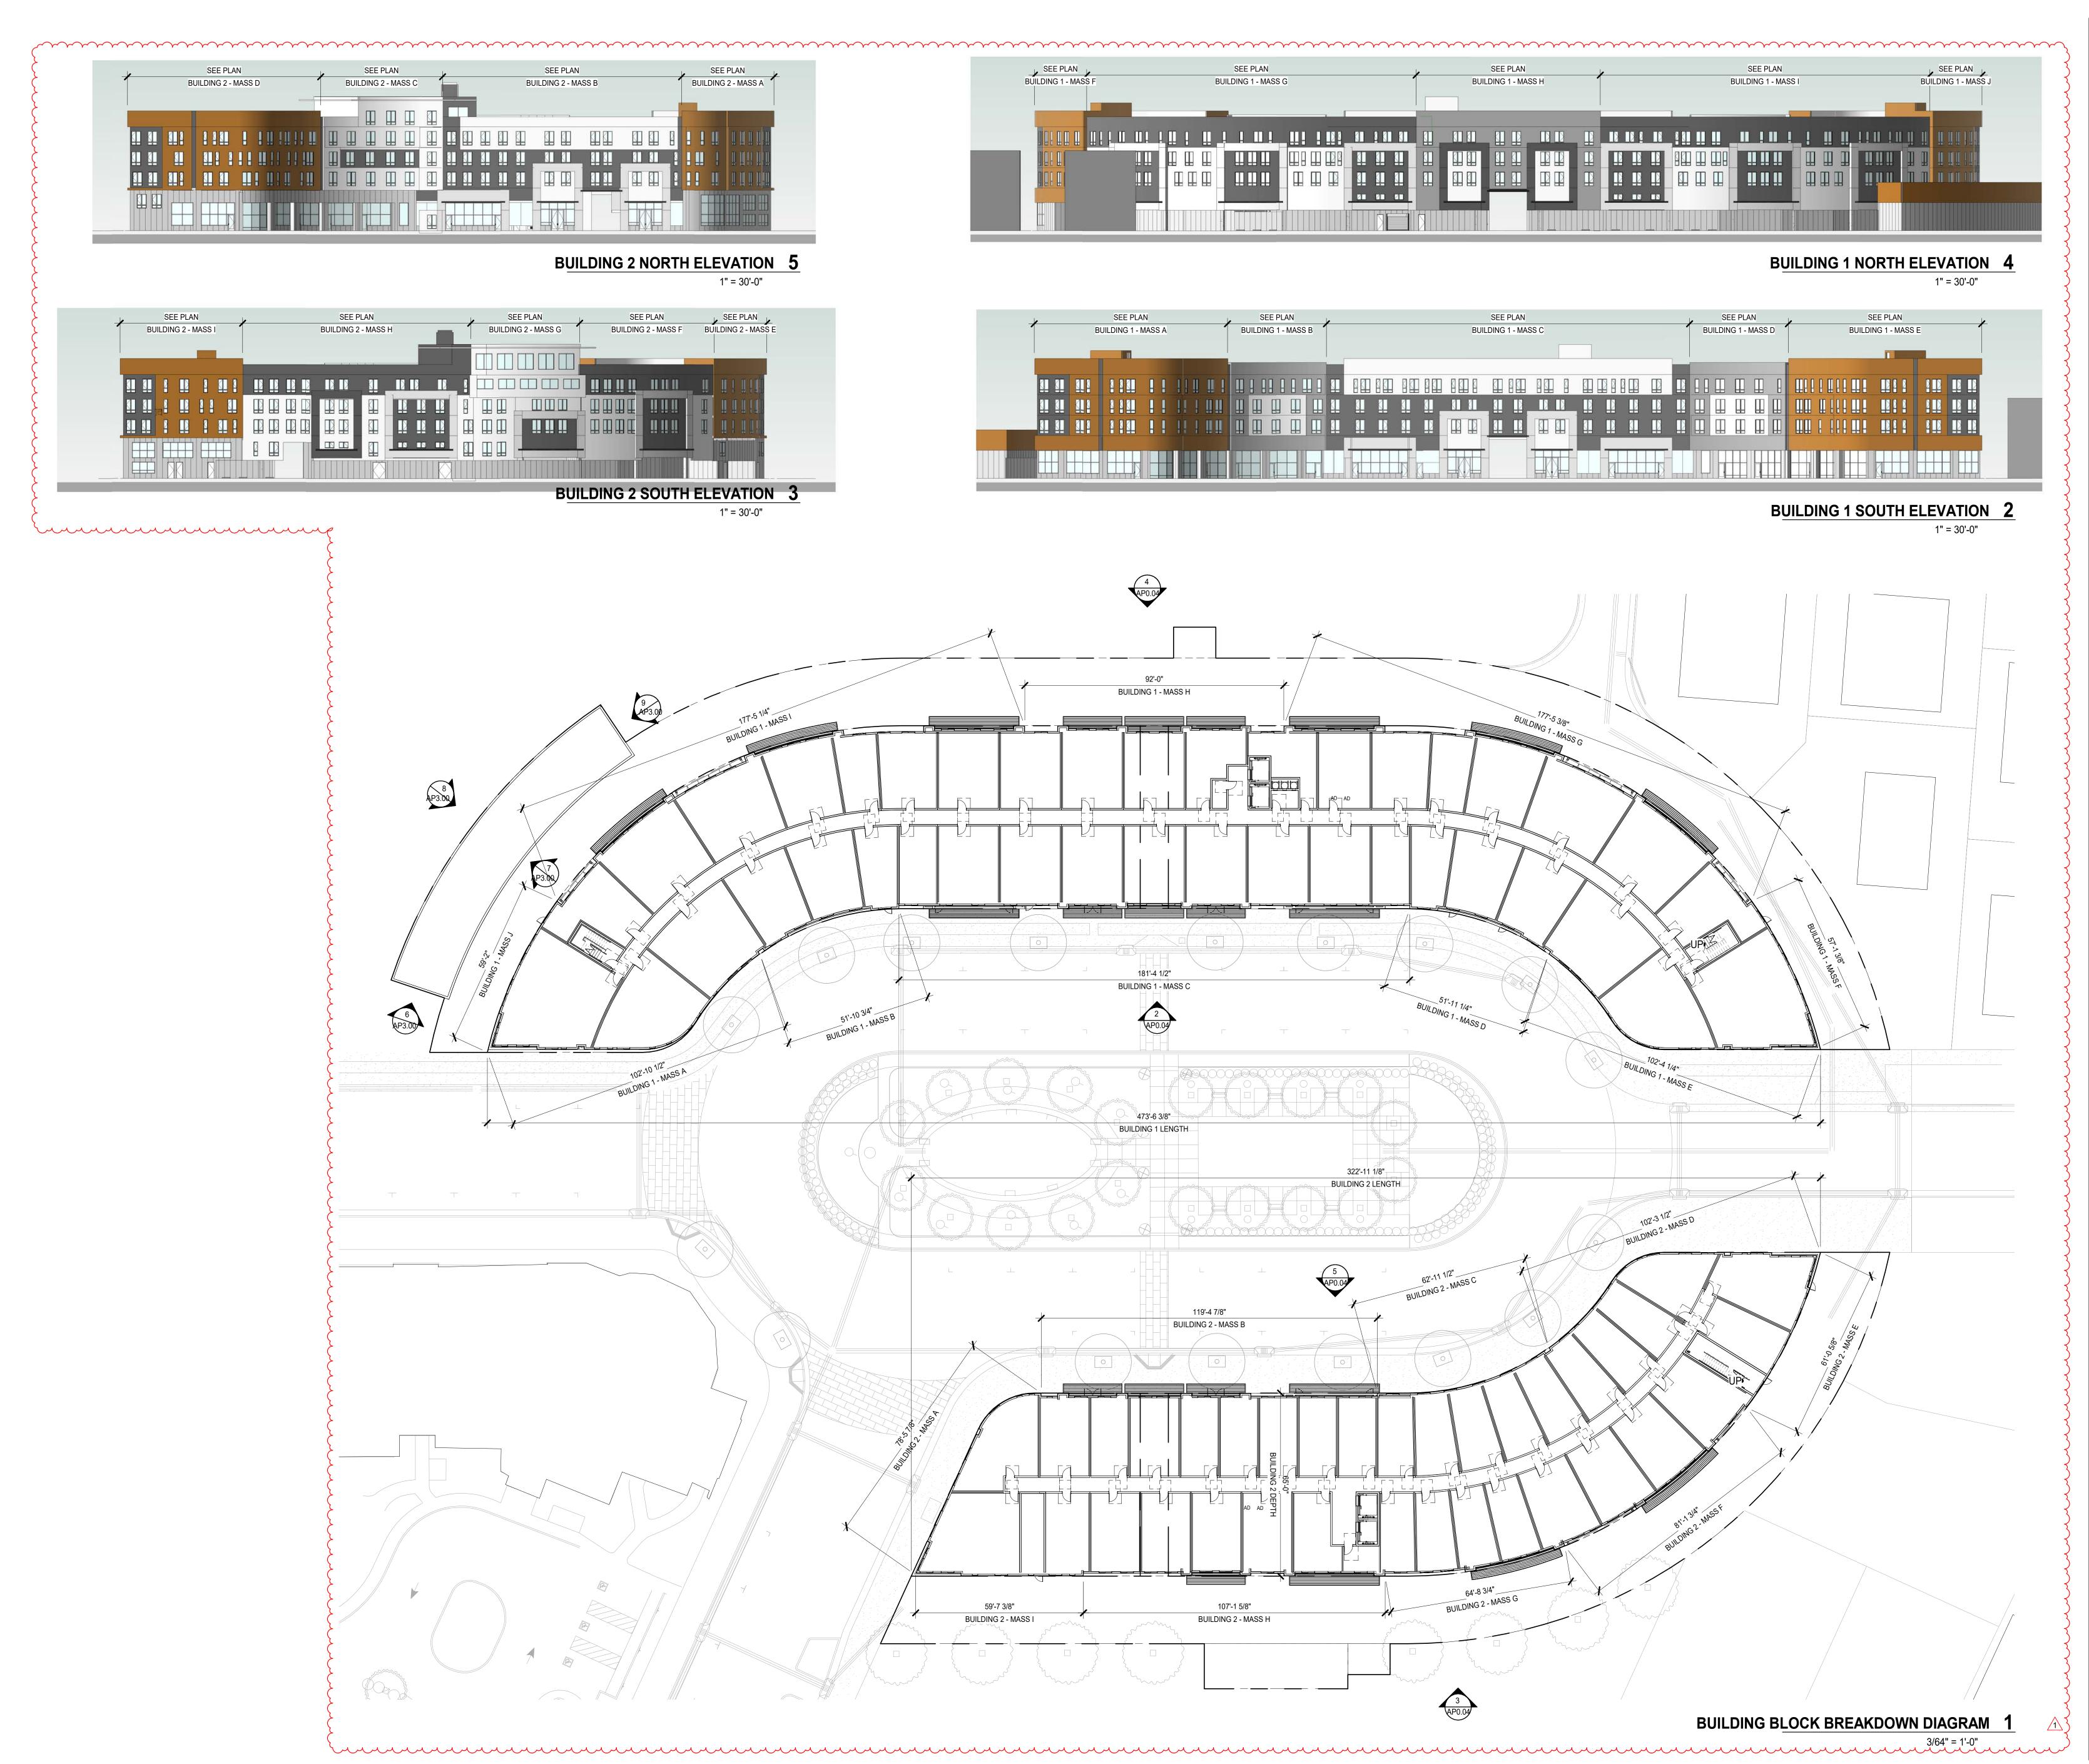
VIEW SHED





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ENTITLEMEN 5.5.22
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PLANNING 6.6.22
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BUILDING BLOCK DIAGRAM

SHEET TITLE:

SCALE: As indicated

PROJ #. 2110 DRAWN BAUTHOR

SHEET SIZE: 30 X 42

AP0.04

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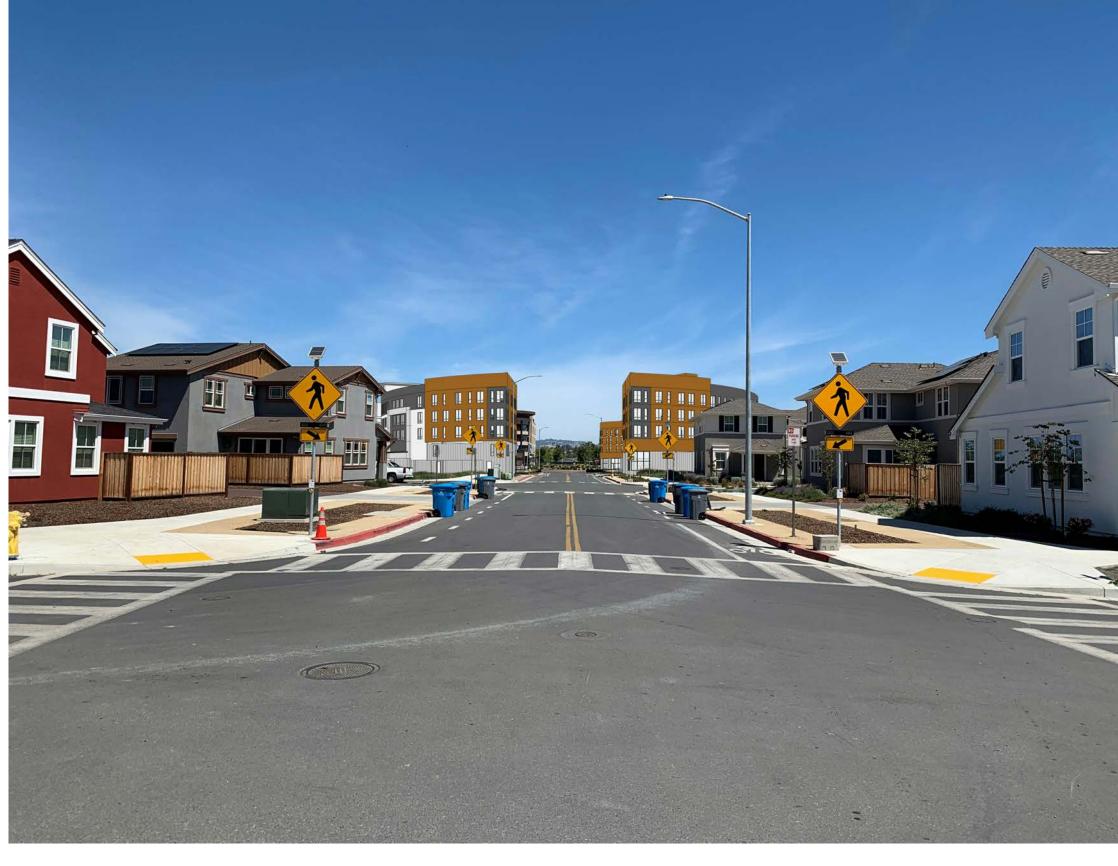
Spirit

SITE SECTION - TRANSVERSE 5 1" = 30'-0"

COURTYARD HOTEL RIVERSCAPE SUBDIVISION

SITE SECTION - LOGINTUDINAL 4

1" = 30'-0"



VIEW CORRIDOR-SOUTH 21 1/2" = 1'-0"





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NEIGHBORHOOD **VIEW DIAGRAM**

SCALE: As indicated PROJ #. 2110 DRAWN BAUTHOR SHEET SIZE: 30 x 42

VIEW CORRIDOR KEY

VIEW CORRIDOR-WEST 3 1 1/2" = 1'-0"

VIEW CORRIDOR-NORTH 1 1/2" = 1'-0"

AP0.05



LAND USE ABBREVIATIONS

[MU] MIXED USE

[DLDR] DIVERSE LOW DENSITY RESIDENTIAL

[MDR] MEDIUM DENSITY RESIDENTIAL
[RL] LOW DENISTY RESIDENTIAL

REVISIONS BY

[RH] HIGH DENSITY RESIDENTIAL
[MH] MOBILE HOMES

[CC] COMMUNITY COMMERCIAL[P/SP] PUBLIC/SEMI-PUBLIC[CP] OPEN SPACE

[NC] NEIGHBORHOOD COMMERCIAL
[RDI] RIVER DEPENDENT INDUSTRIAL

] LAND USE DESIGNATION

ZONING ABBREVIATIONS

RDI RIVER DEPENDENT INDUSTRIAL (D-3)

RDI RIVER DEPENDENT INDUS

T-4 URBAN GENERAL

T-5 URBAN CENTER

T-6 URBAN CORE

PUD PLANNED UNIT DISTRICT
PCD PLANNED COMMUNITY DEVELOPMENT

MU1A MIXED USE 1A

MU1B MIXED USE 1B

MH MOBILE HOME PARK

TD THOROUGHFARE DISTRICT (D4)

CS CIVIC SPACE

FW FLOODWAY

OSP OPEN SPACE—PARK

R5 RESIDENTIAL 5
C1 COMMERCIAL 1

C2 COMMERCIAL 2

- - EXISTING CITY LIMIT LINE

CENTRAL SPECIFIC PLAN BOUNDARY (CPSP)

PROJECT BOUNDARY

CONCEPTUAL AREA BOUNDARY (CPSP)

APPROXIMATE FLOODWAY AREA
PER FEMA MAPS DATED
OCTOBER 2, 2015.

MU] — LAND USE CLASSIFICATION

....

____ ZONING DISTRICT

OTES:

 ZONING AND LAND USE INFORMATION SHOWN HEREON IS PER THE CITY OF PETALUMA OFFICIAL CITY WEBSITE ZONING AND LANDUSE ACTIVE MAPPING.


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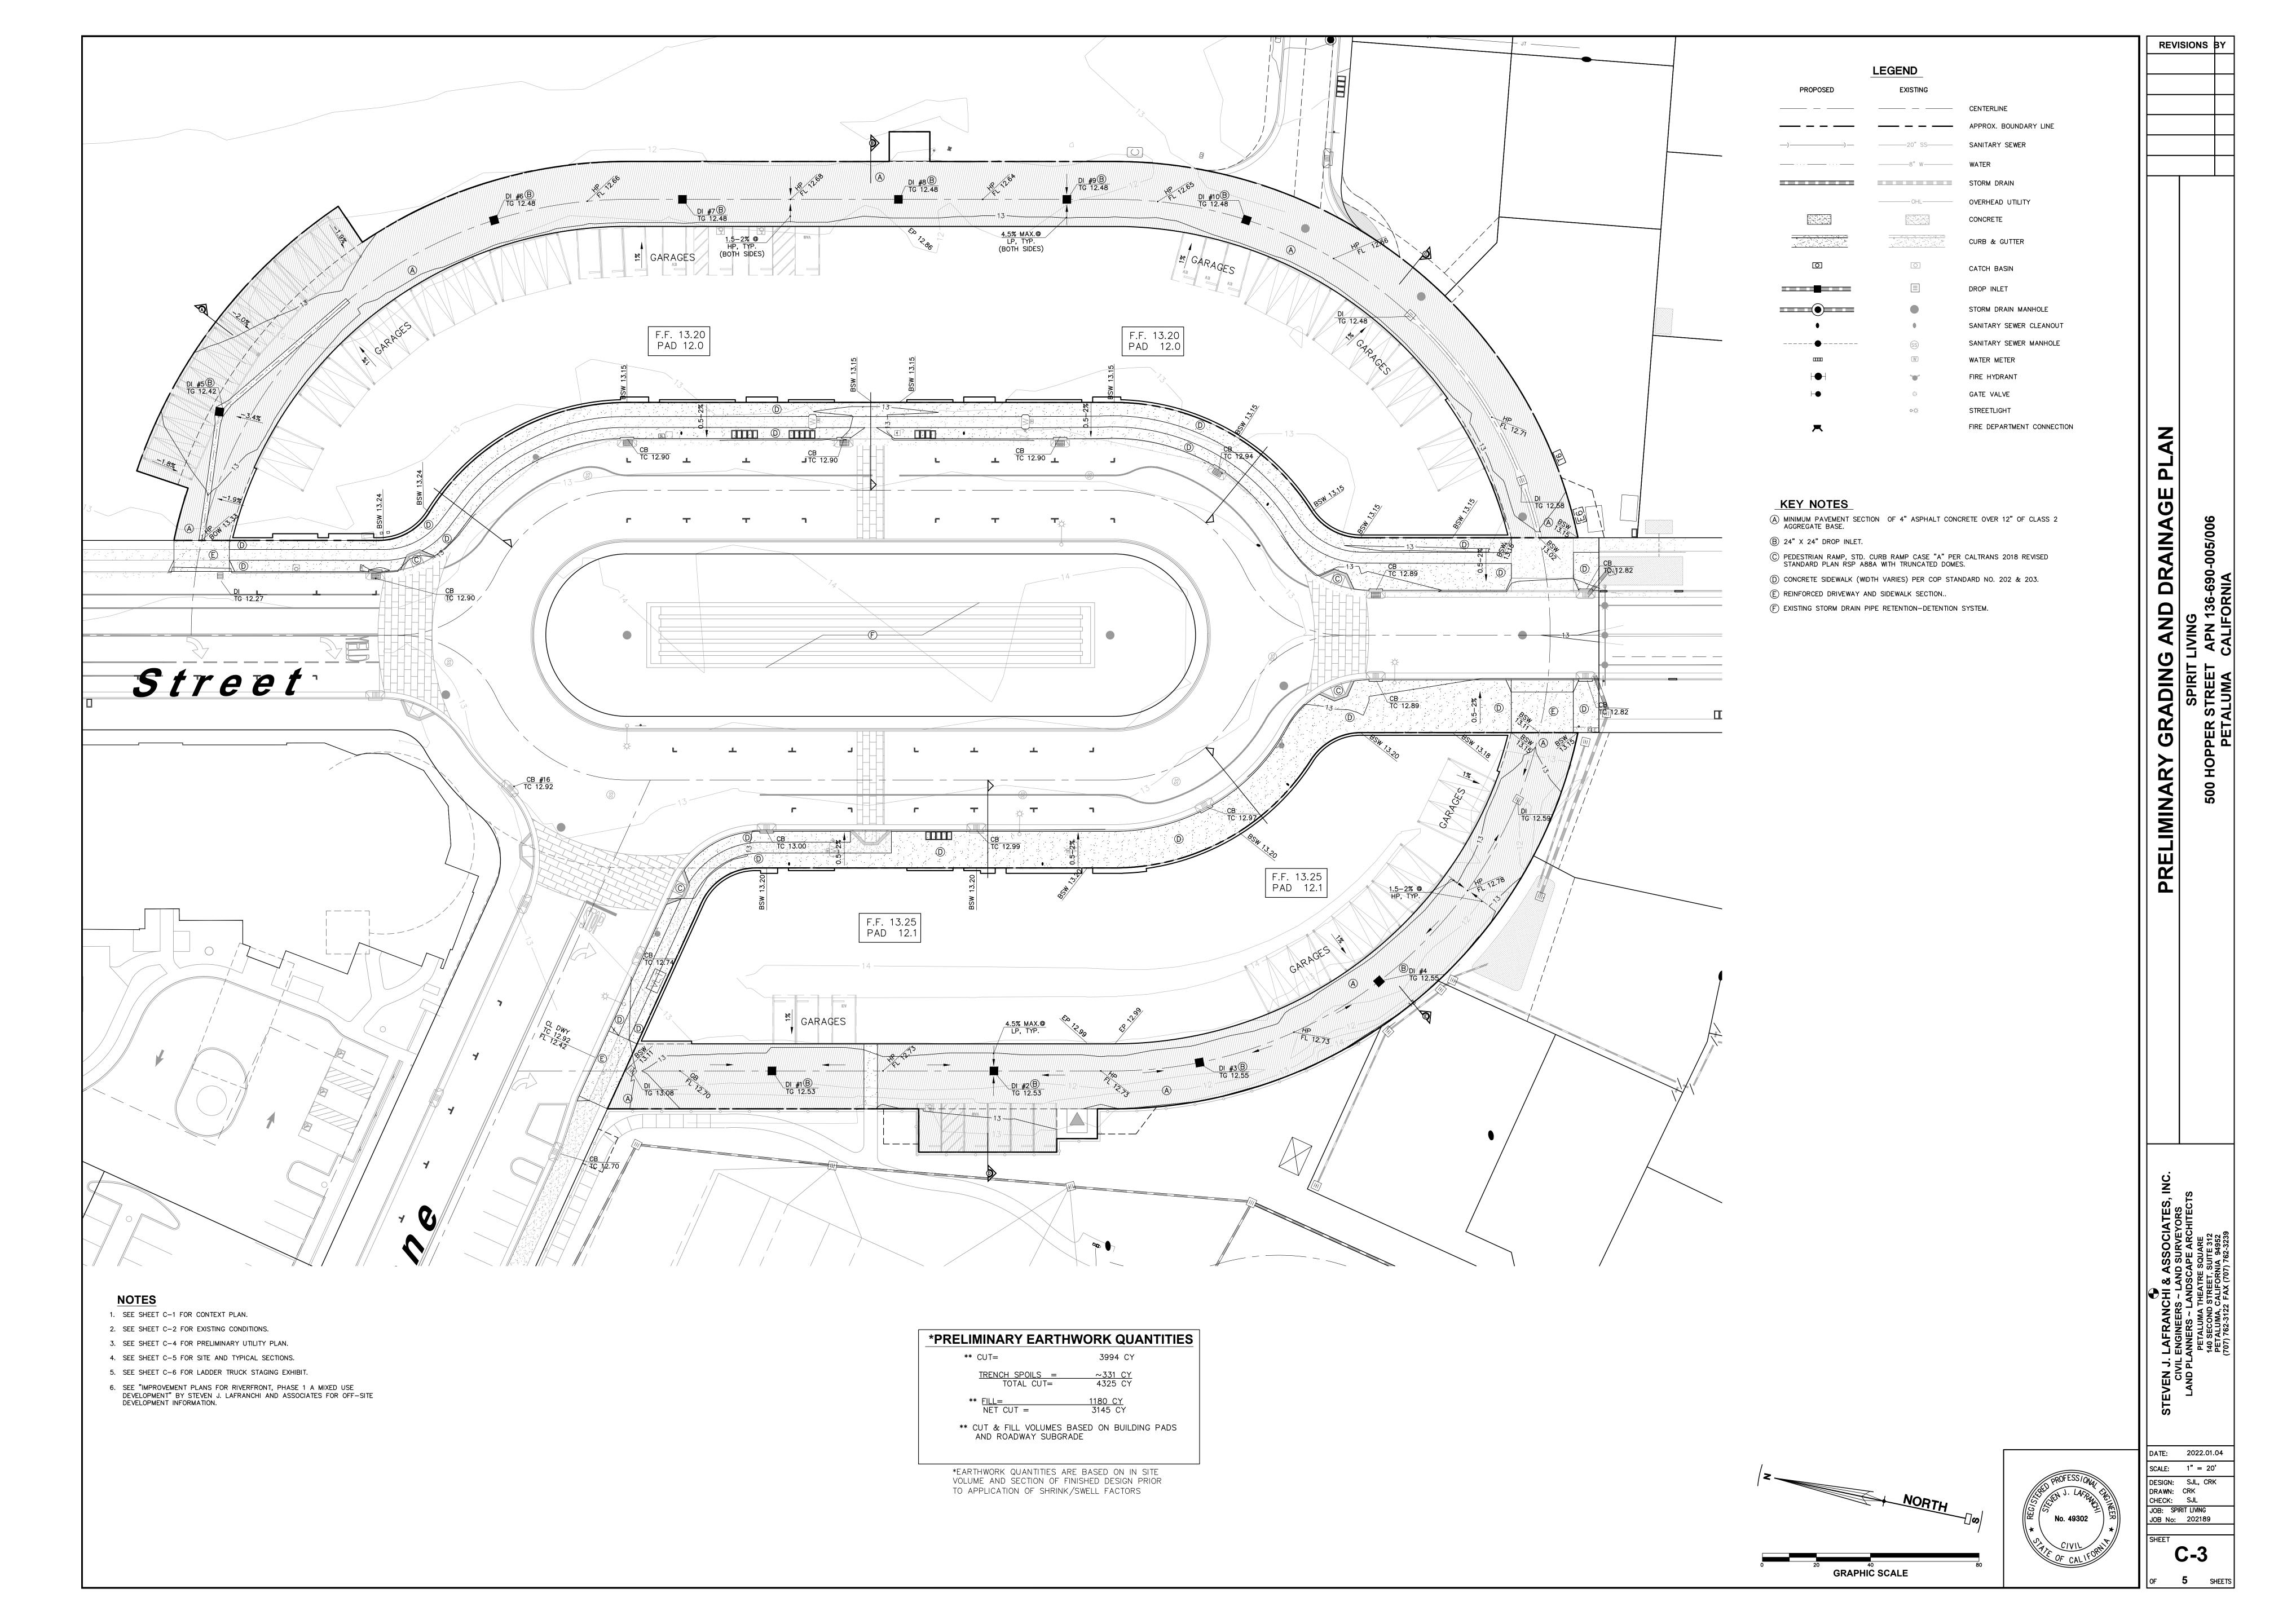
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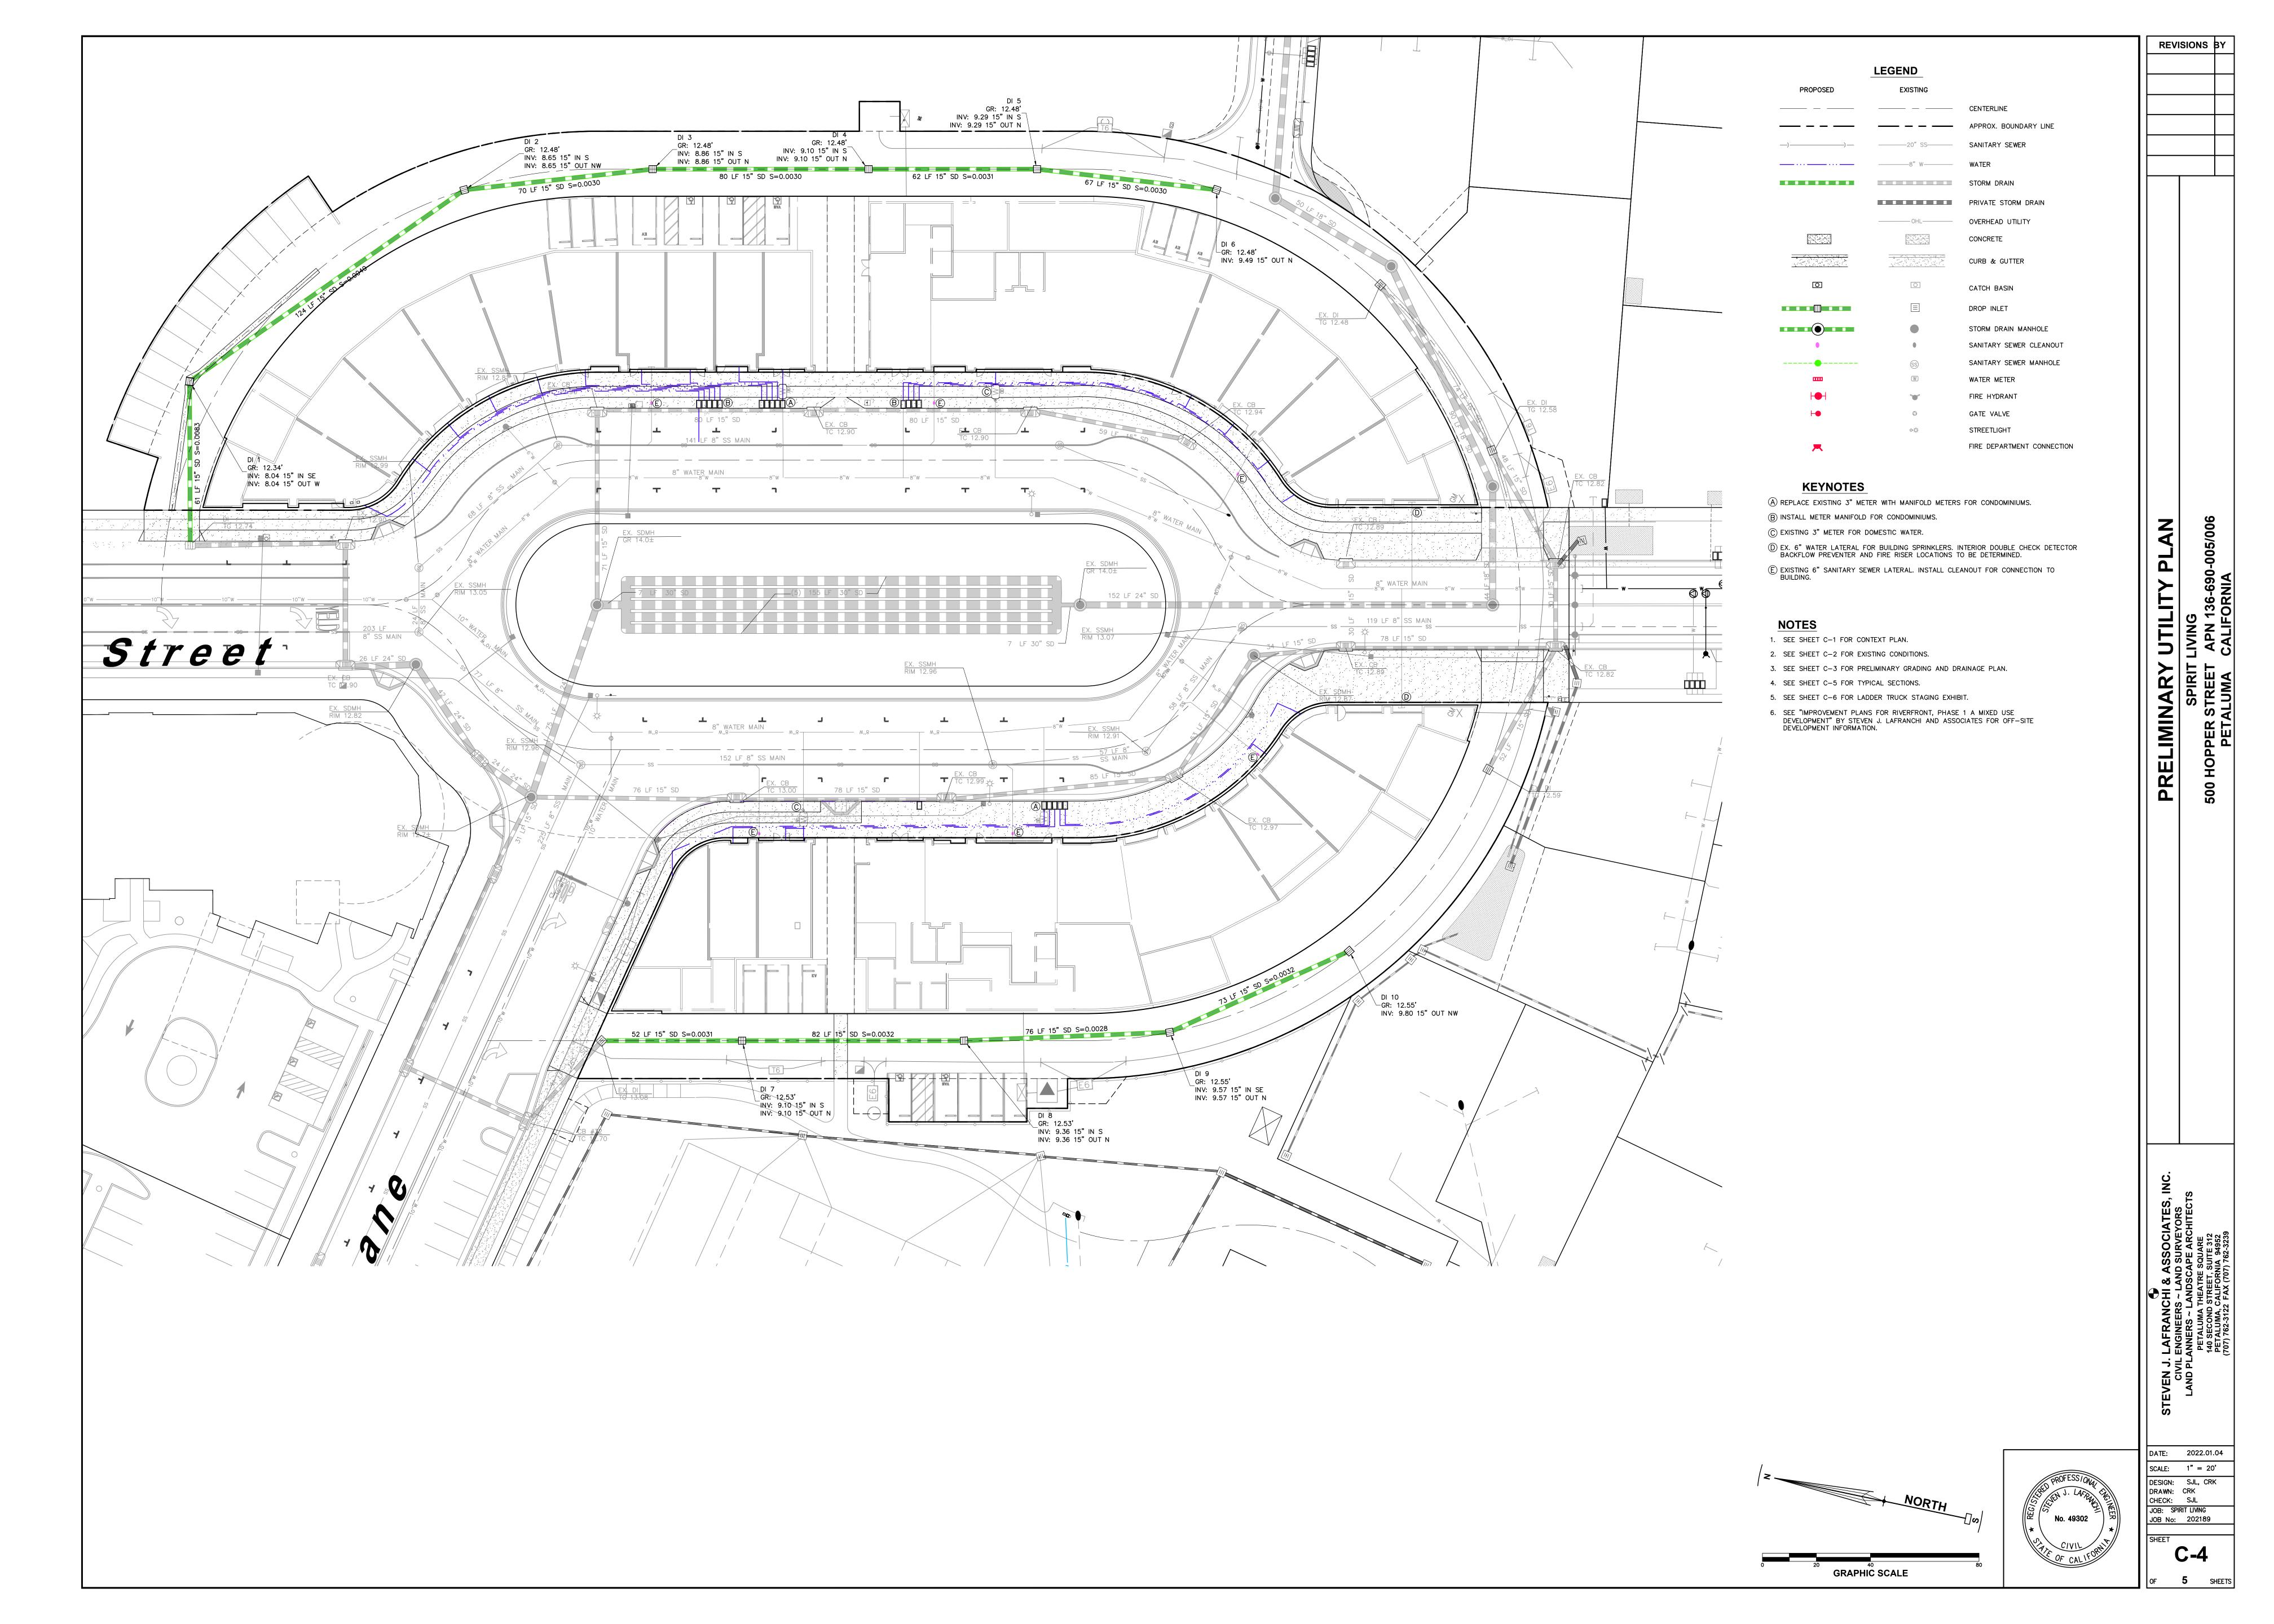
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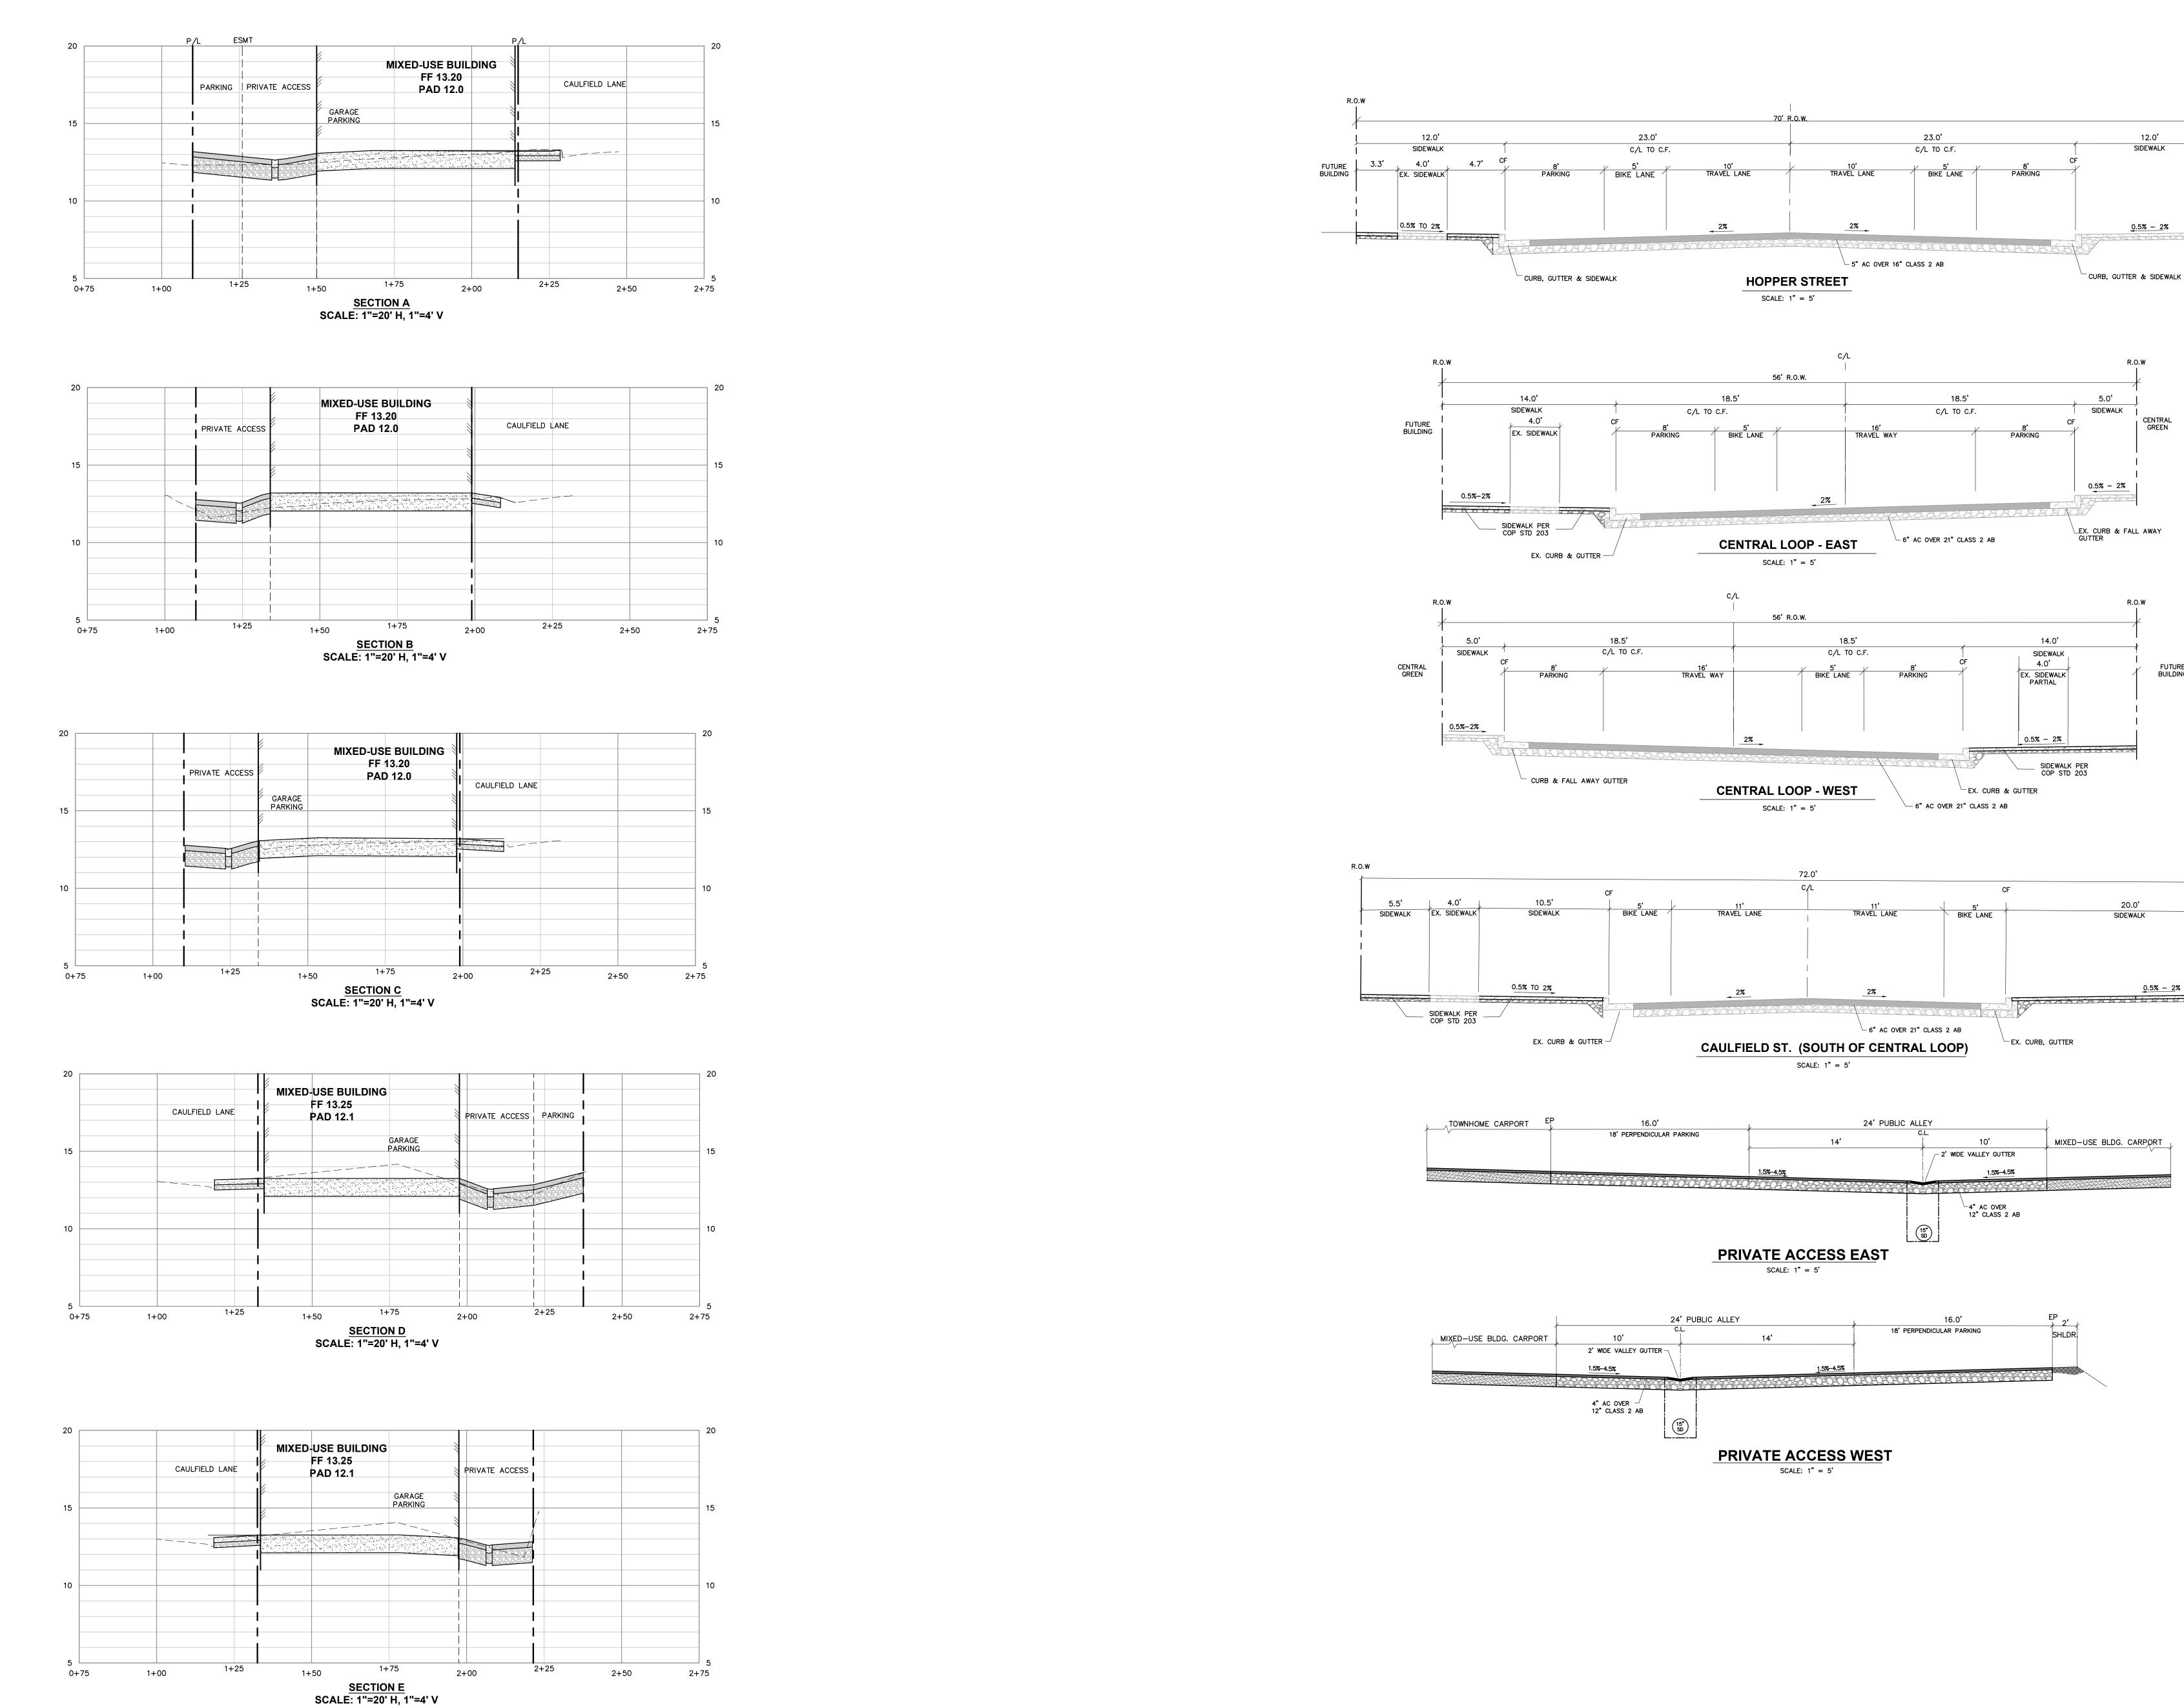
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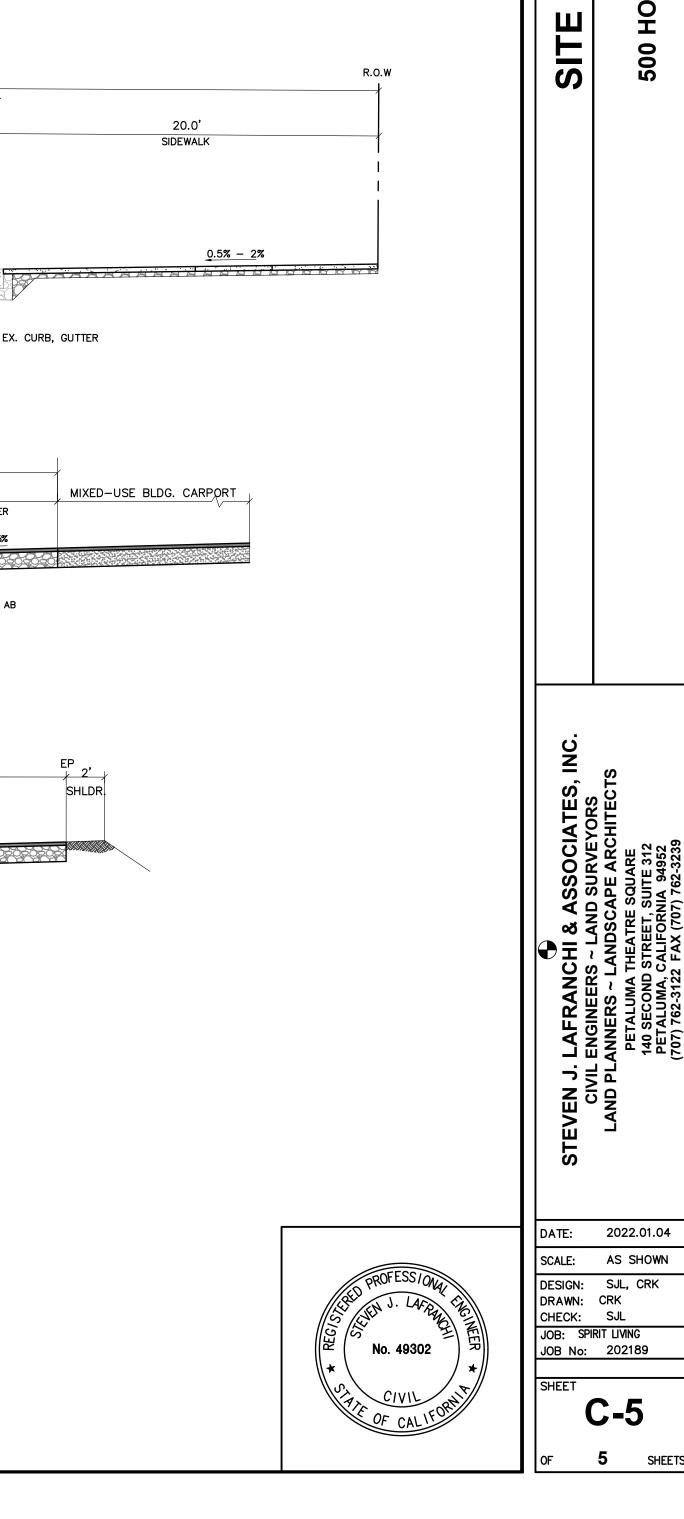
| C-1











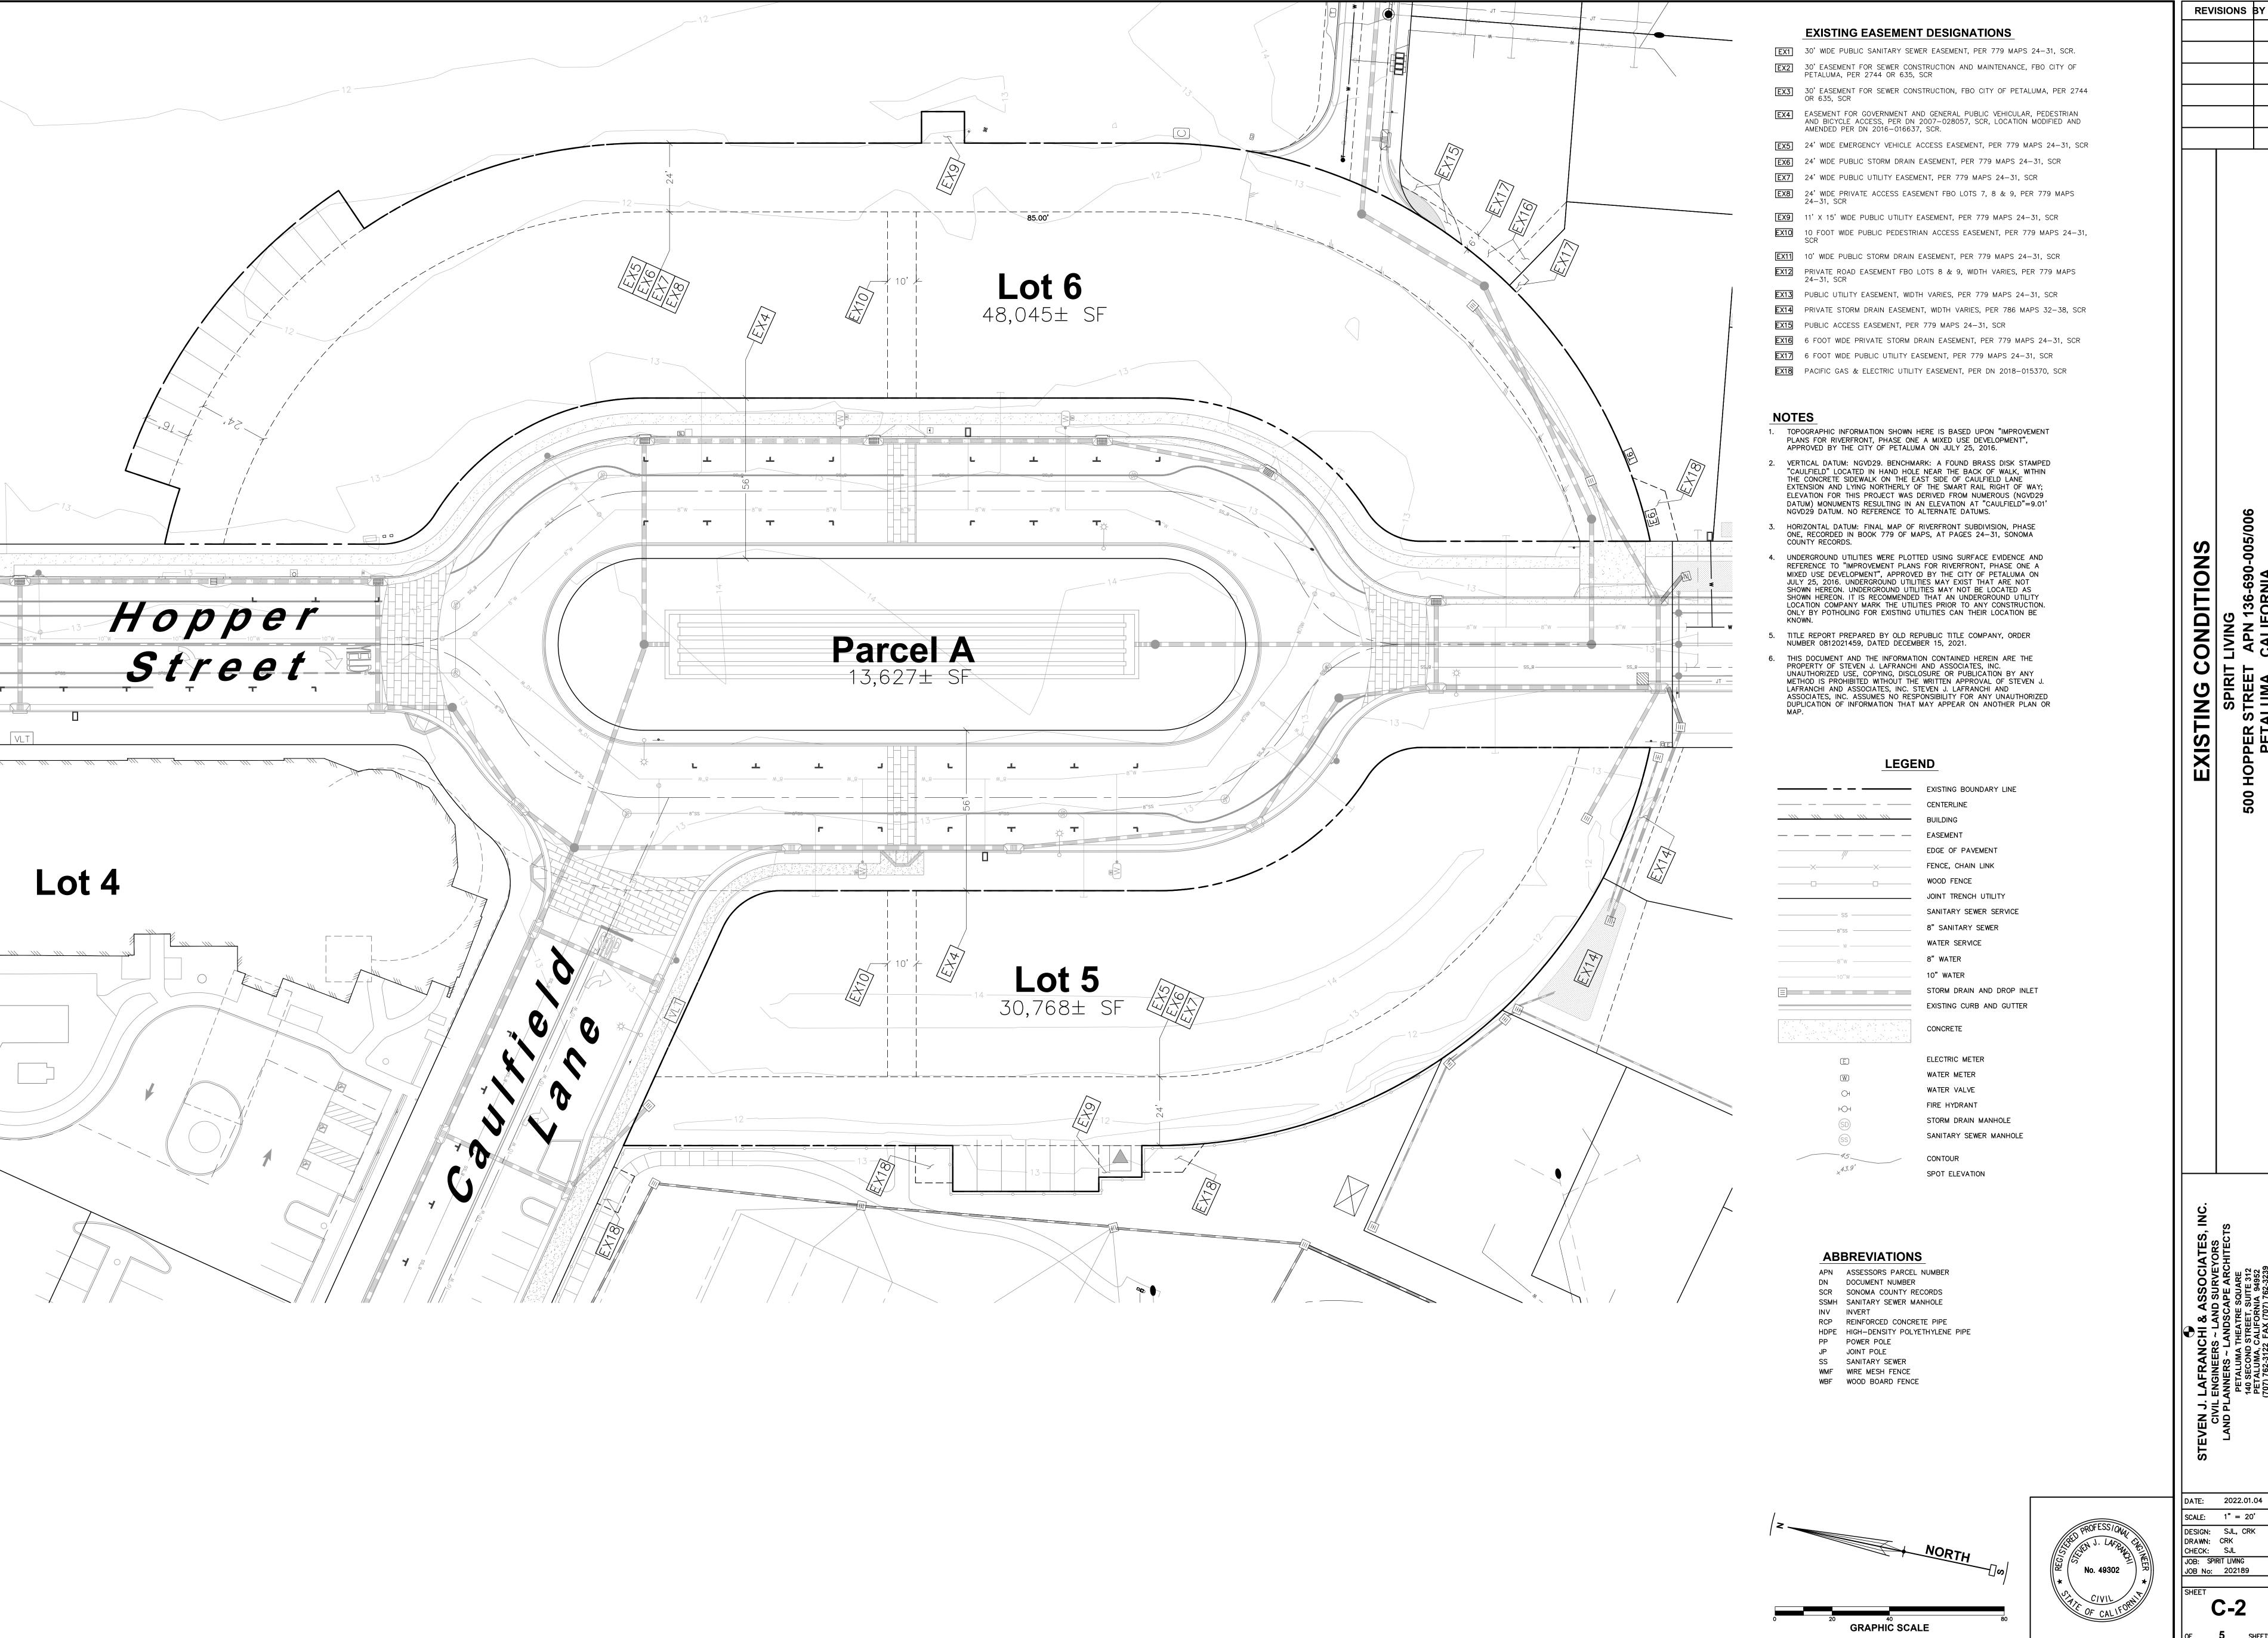

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SIDEWALK



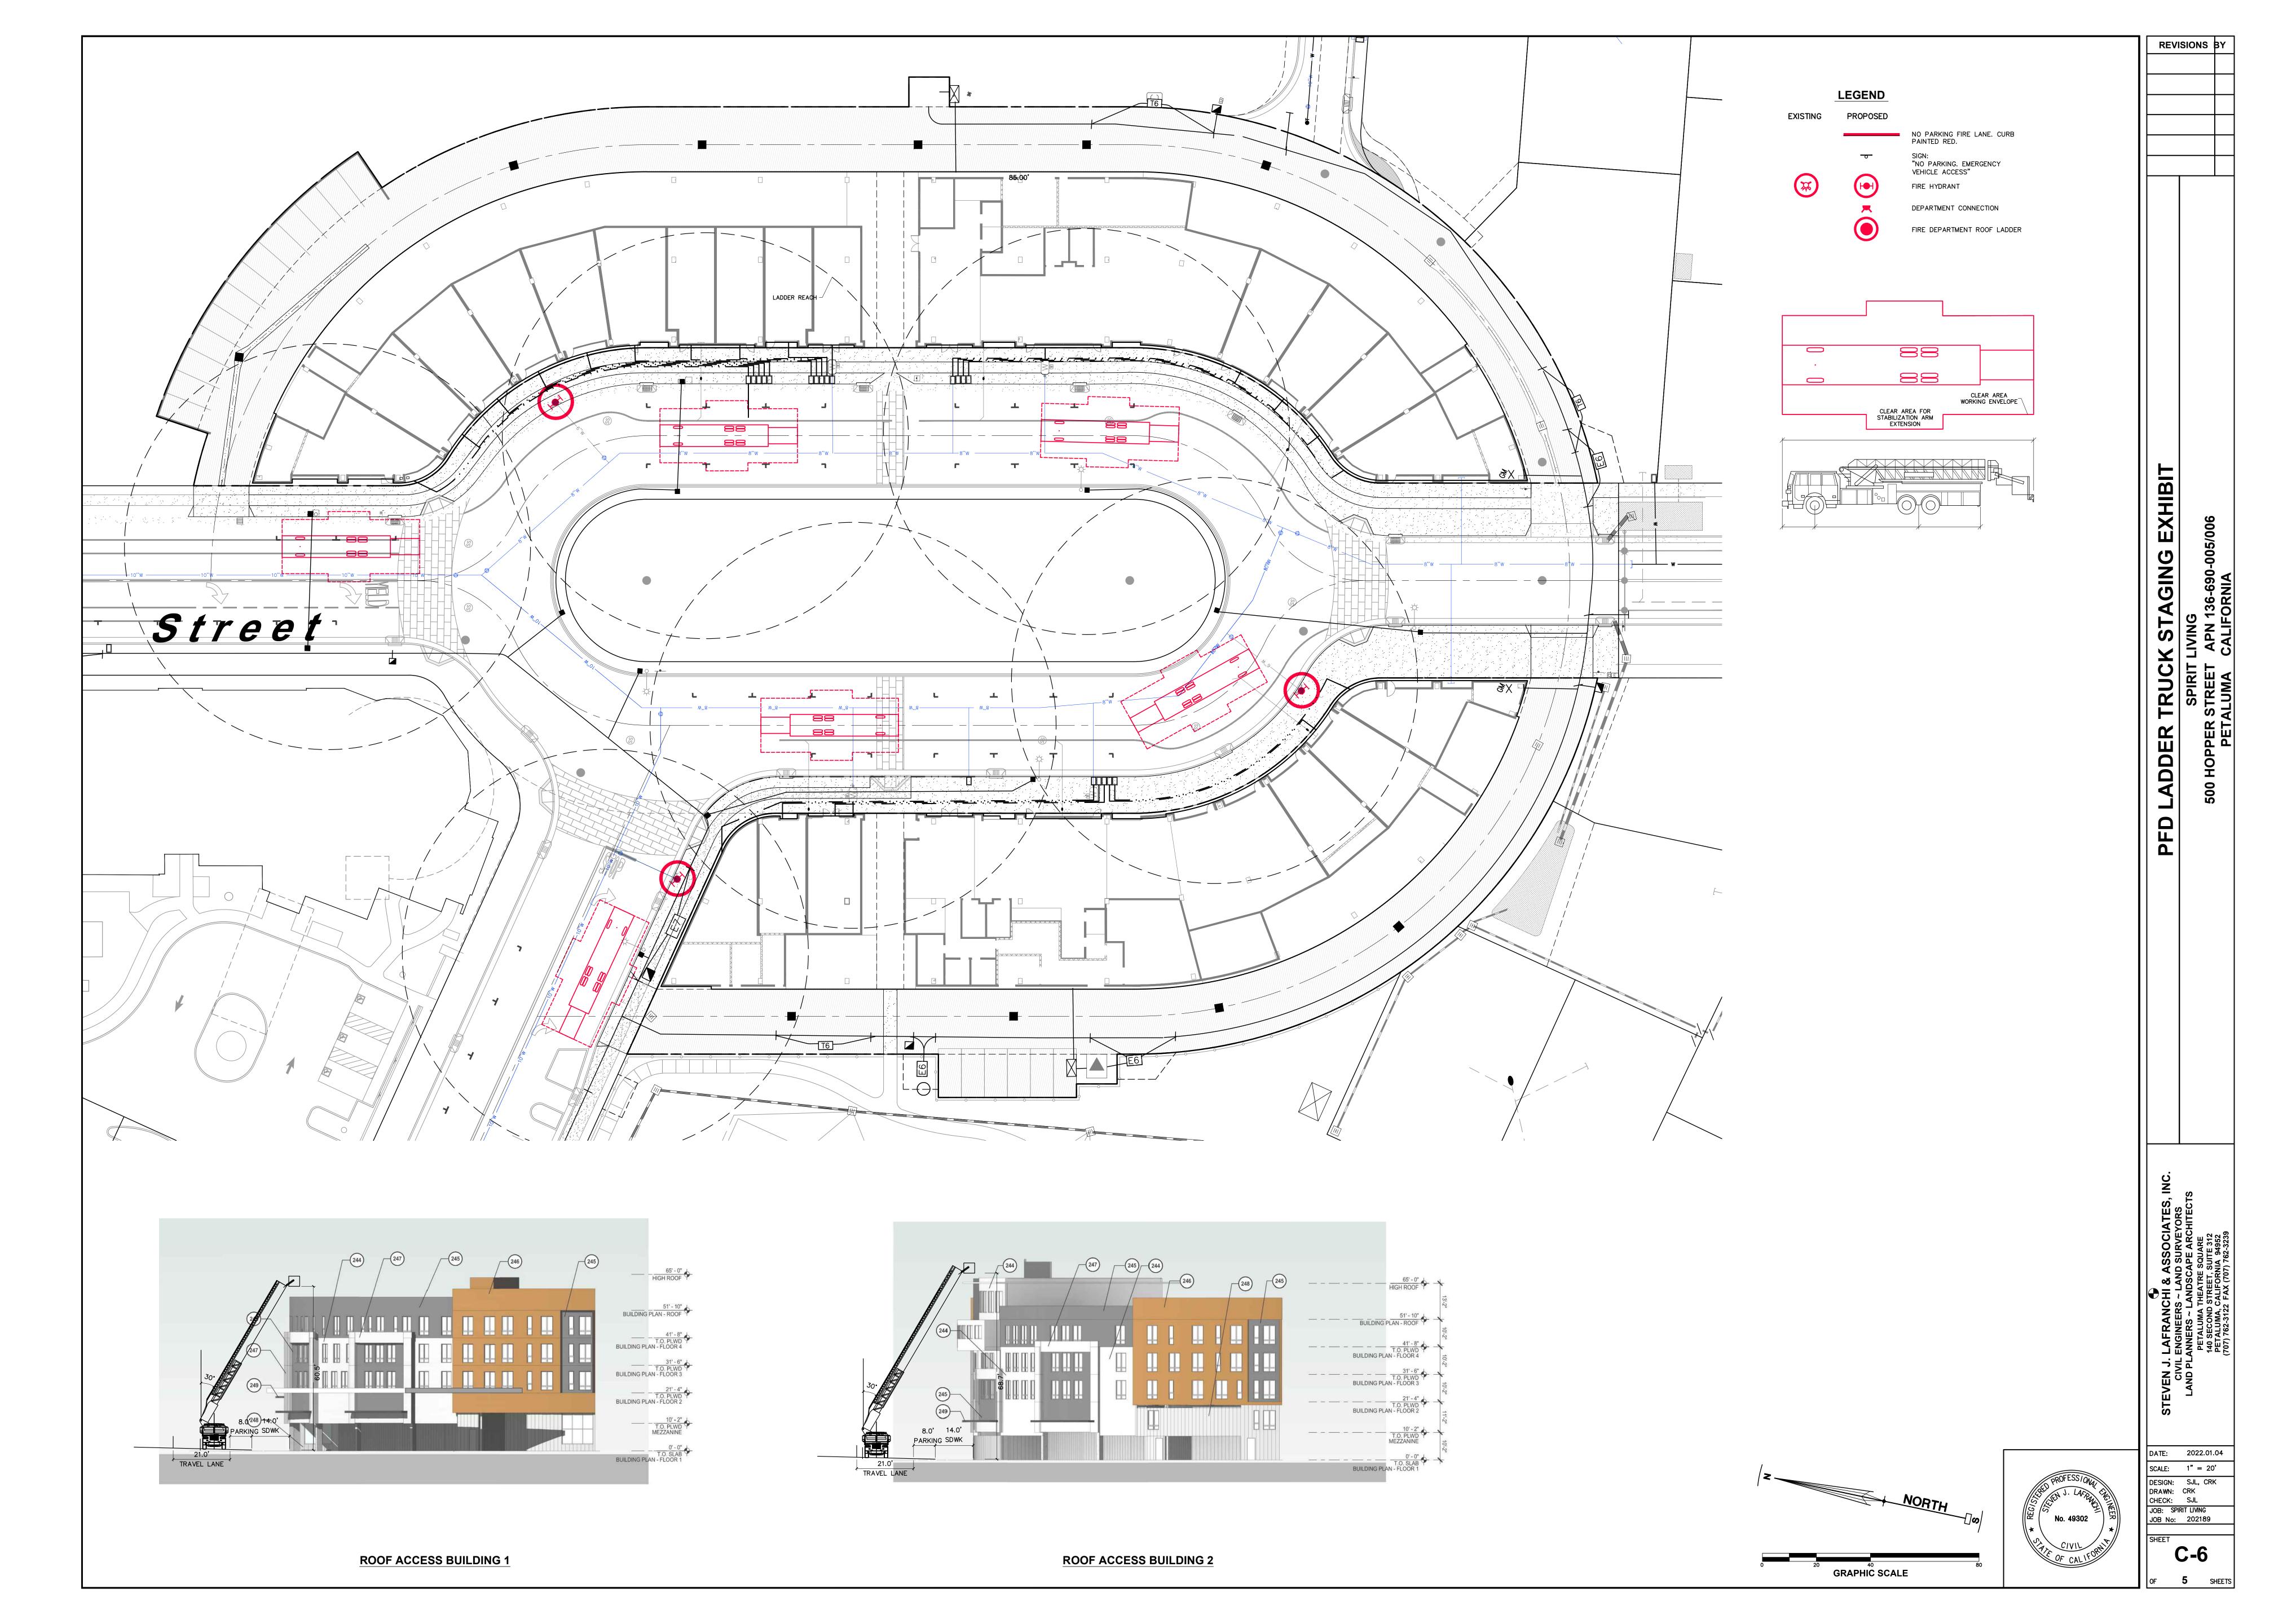


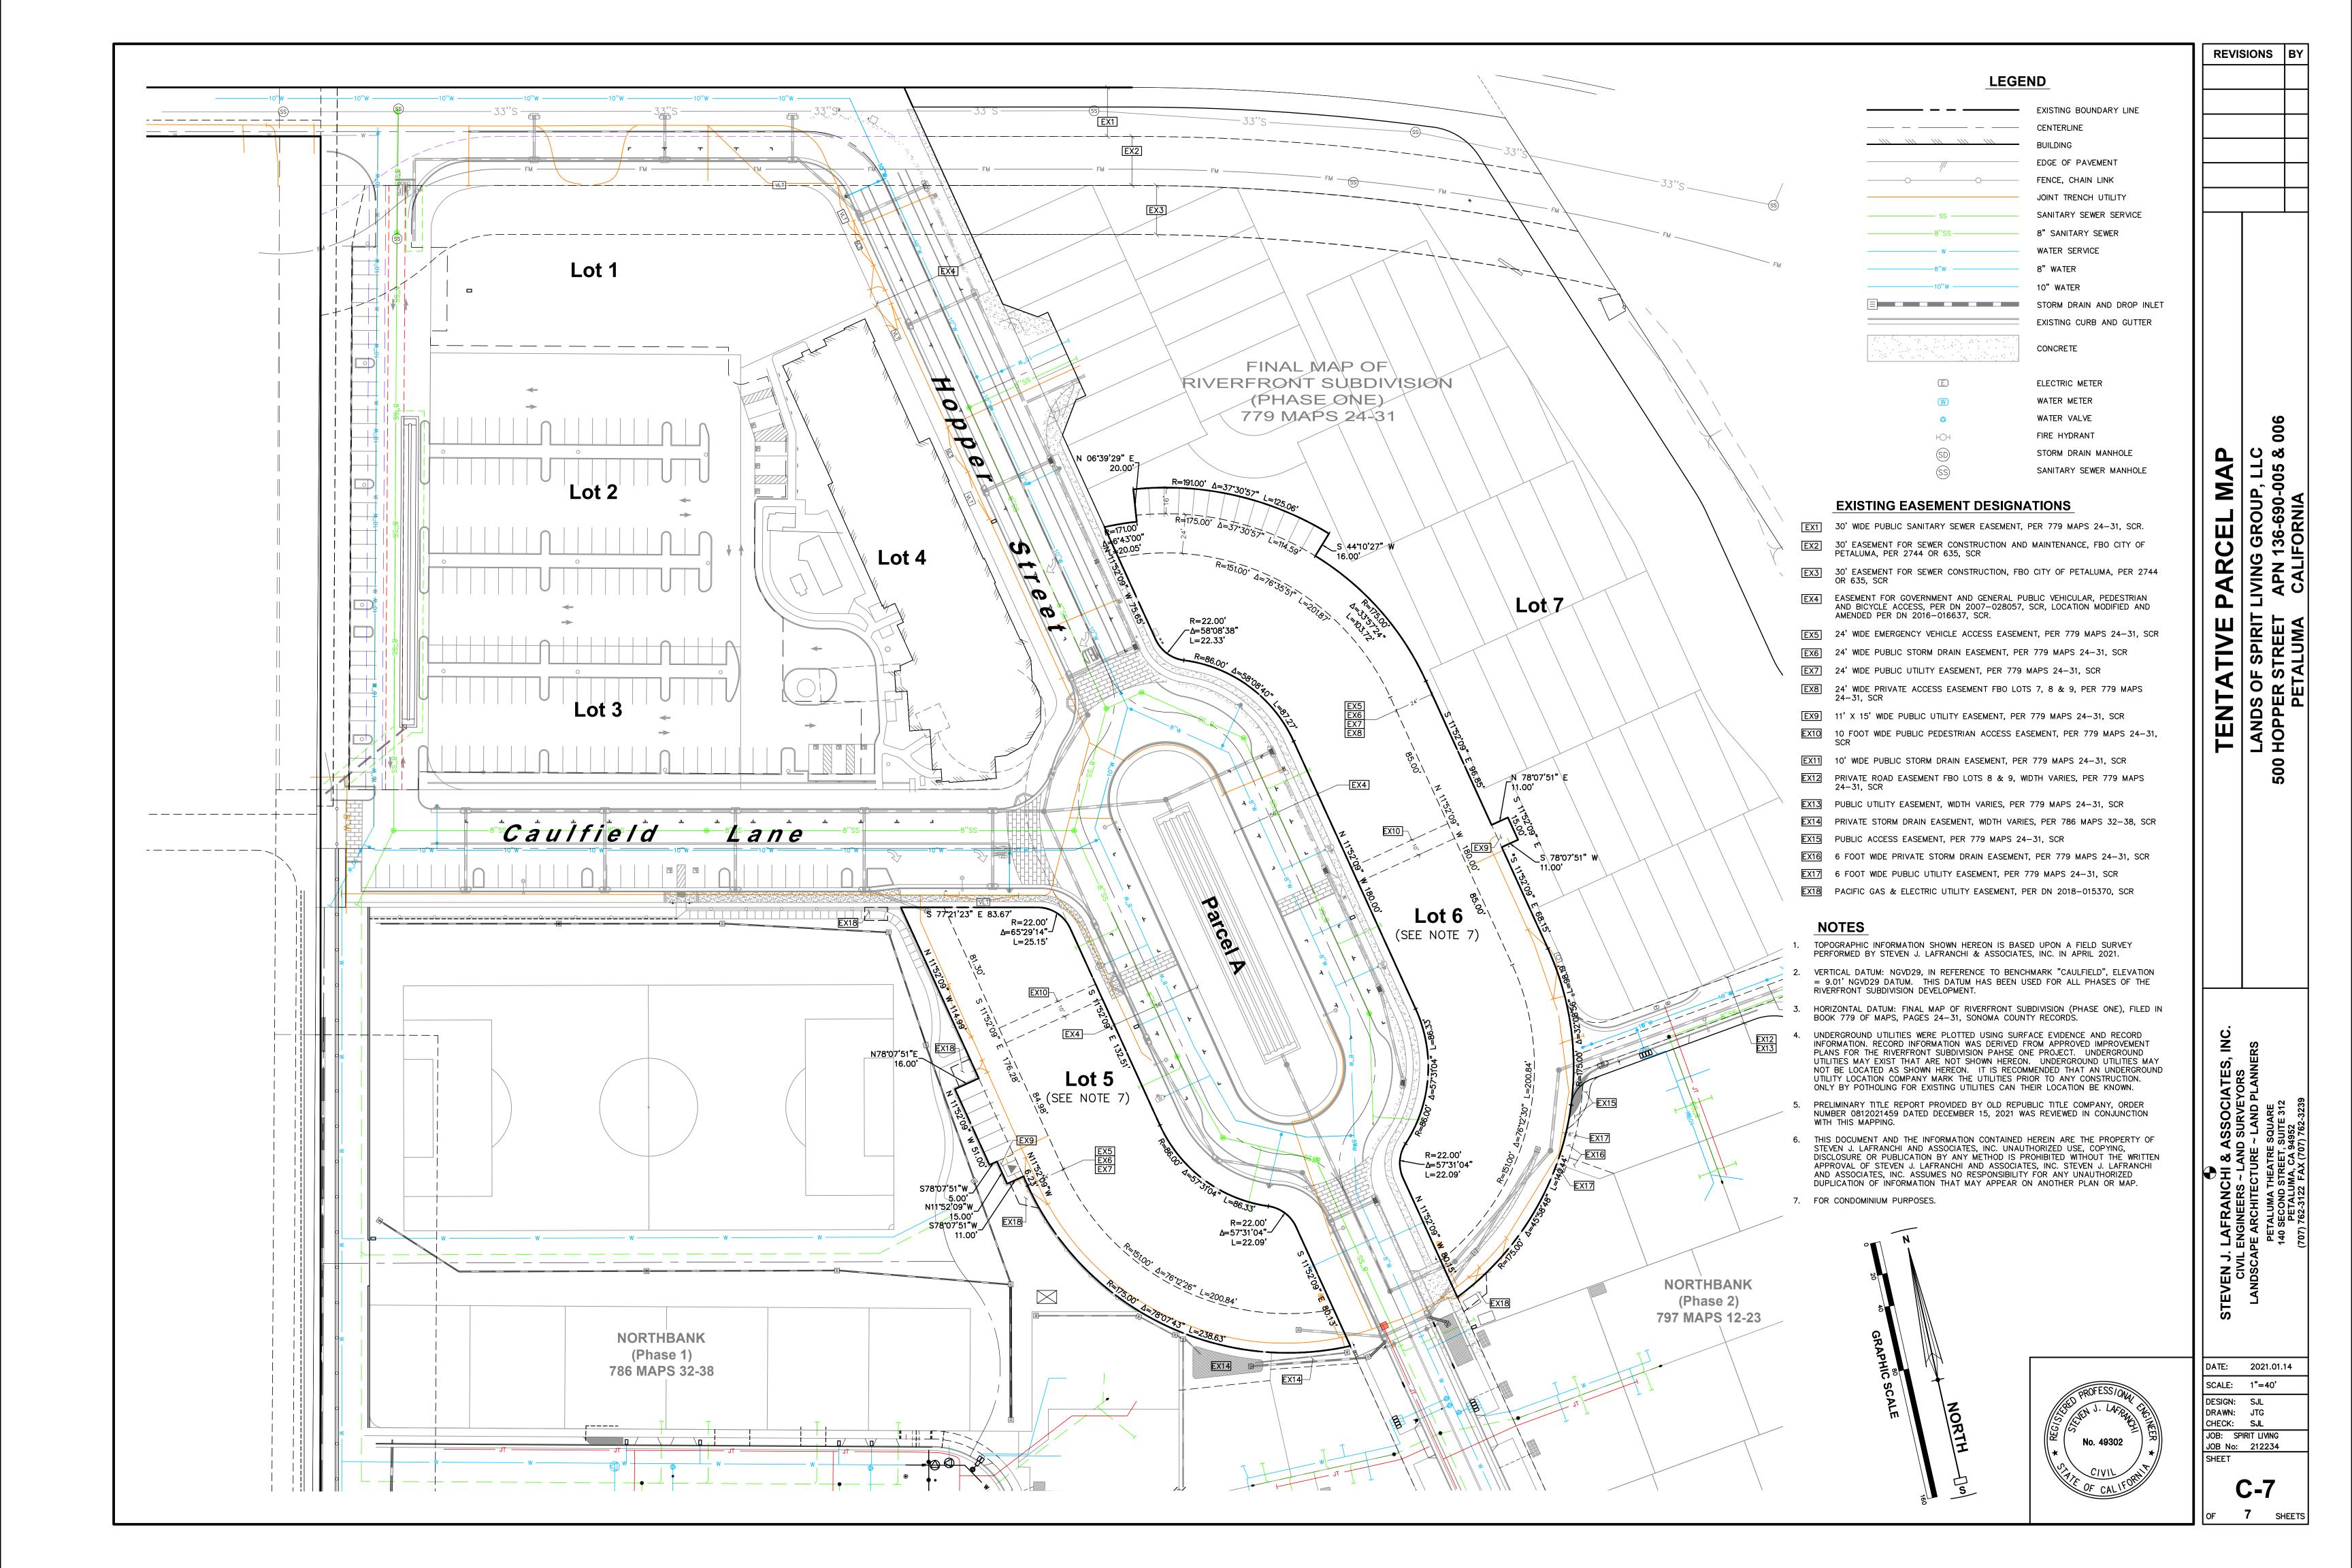SITE LIGHTING PLAN

SCALE AS INDICATED

PROJ.# 2023-068 DRAWN BY AF/CL

SHEET SIZE 30 x 42

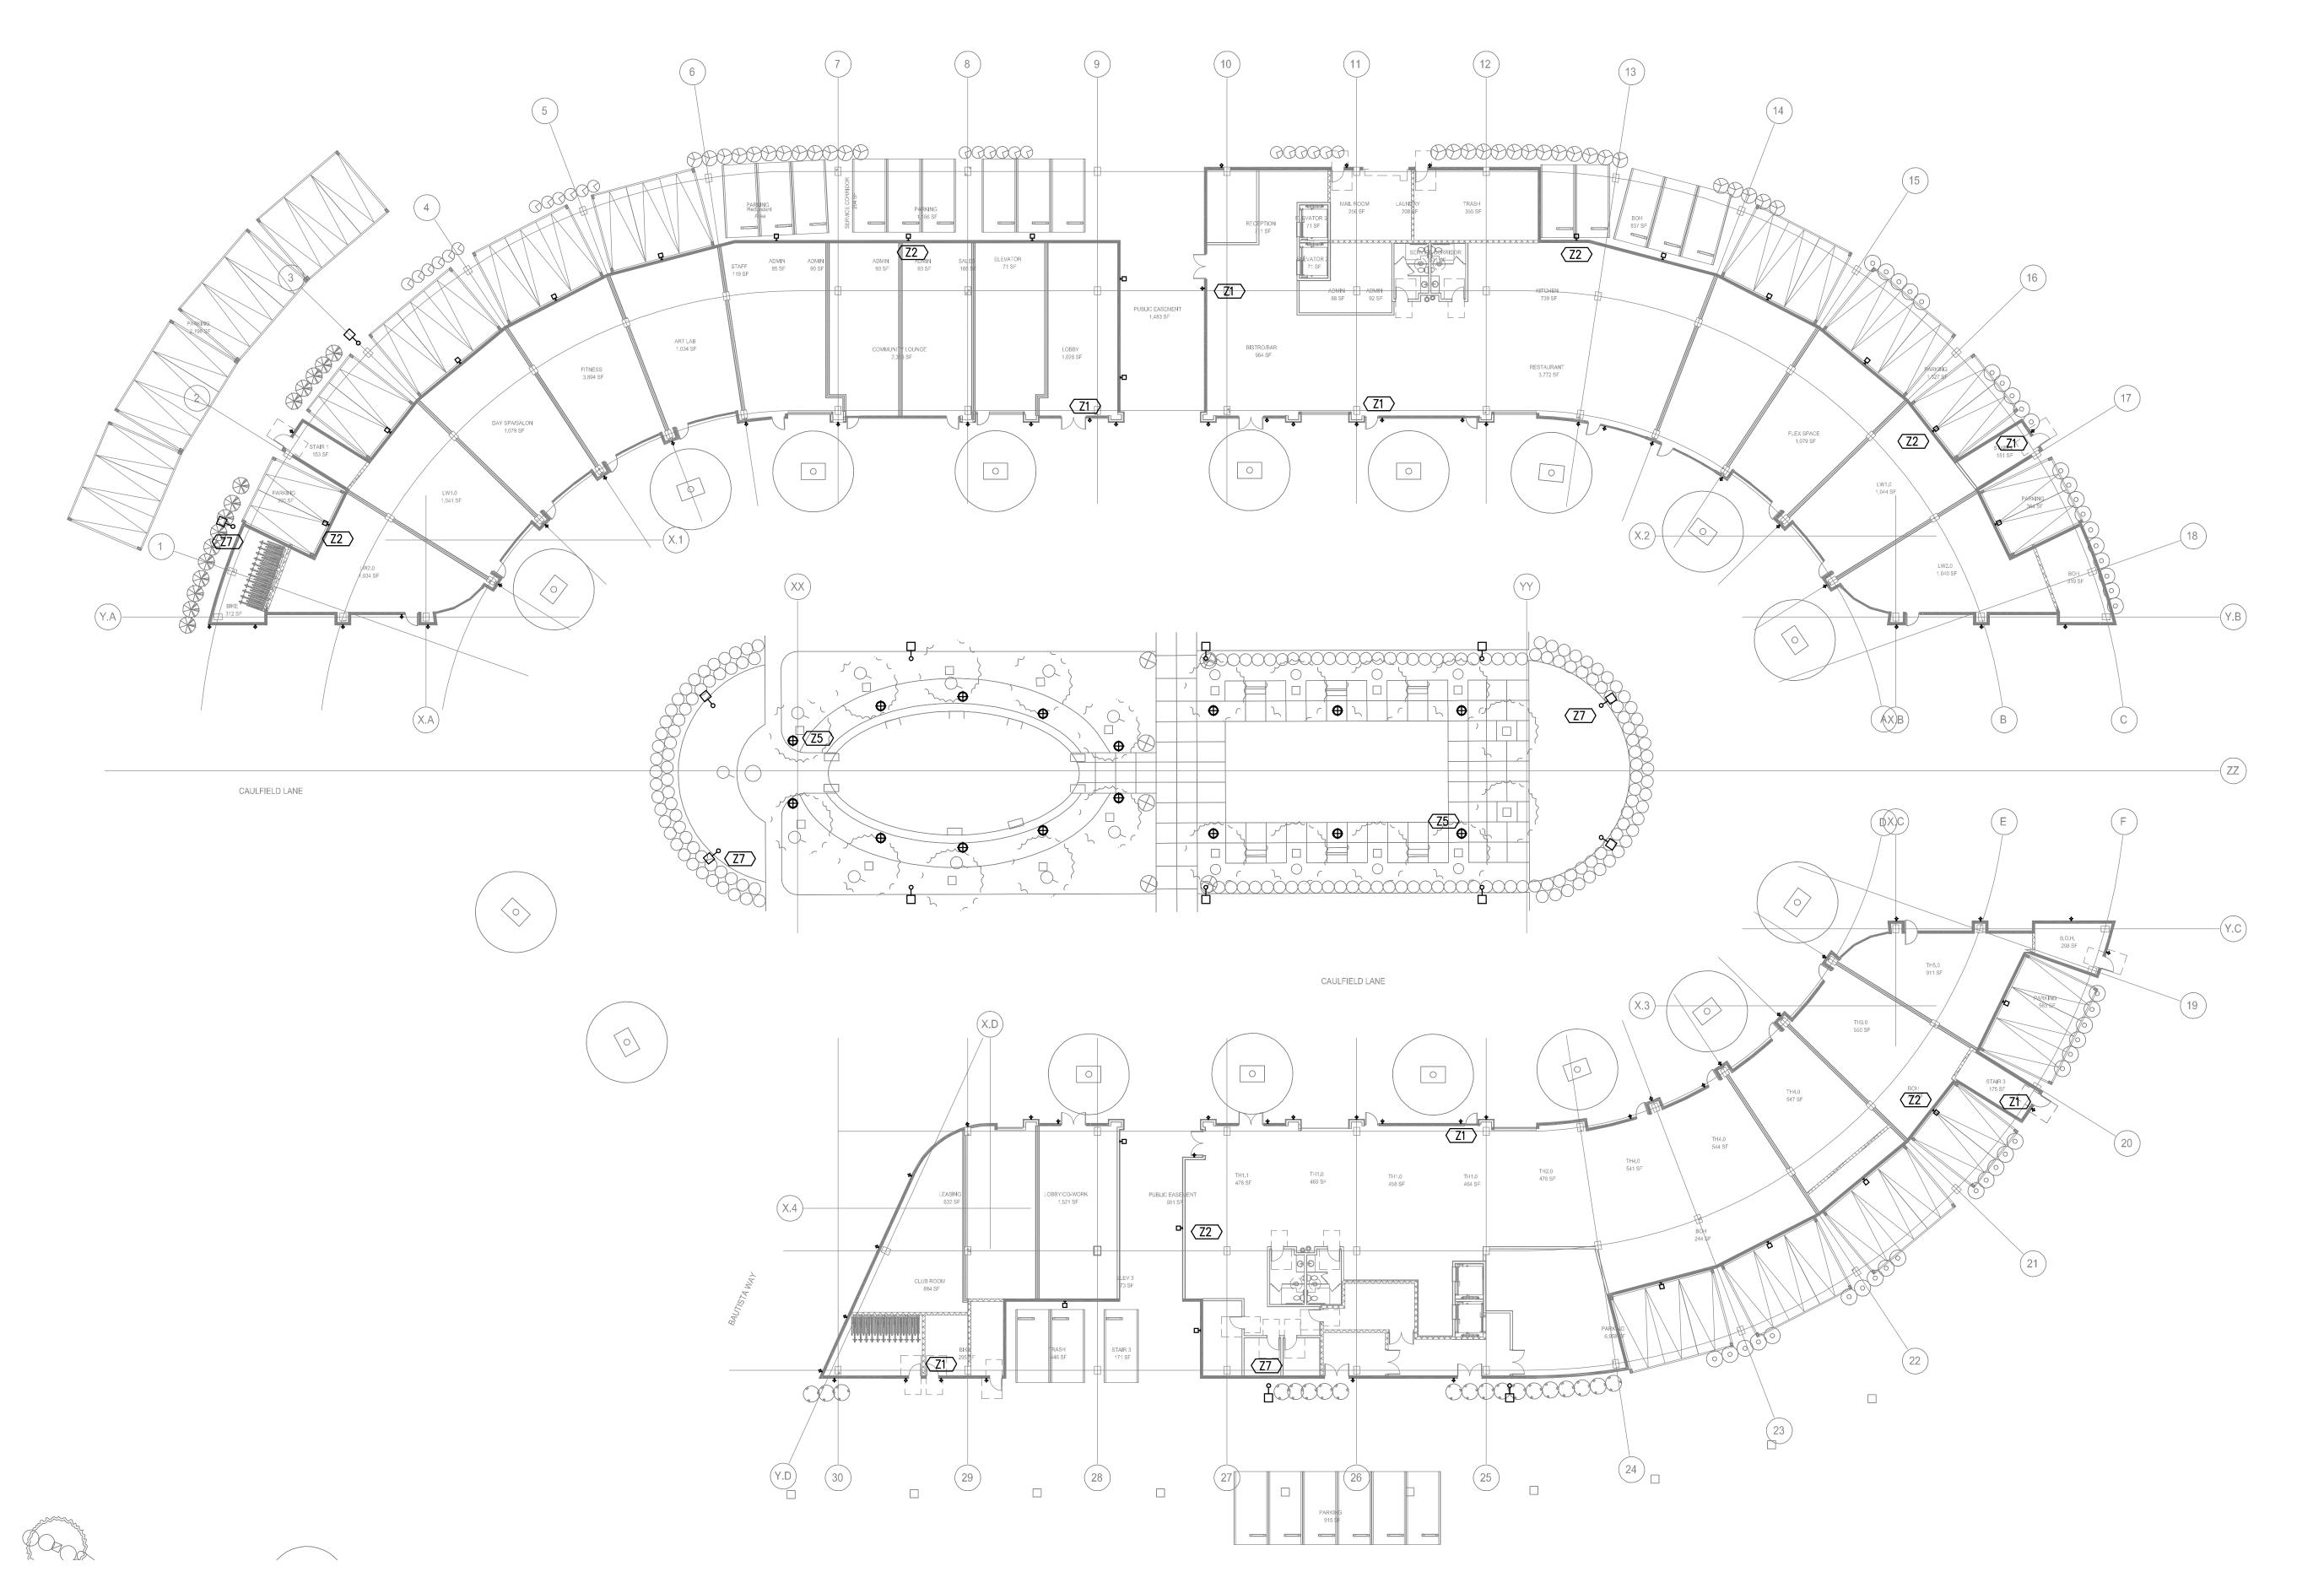

<u>LIGHTING PLAN</u>

FLAG NOTES

SHEET NOTES:

1. EXTERIOR LIGHTING TO BE CONTROLLED VIA PHOTOCELL

2. STREET LIGHTING NOT INCLUDED IN PLAN/PHOTOMETRIC

1. NOT USED

SITE

SCALE: 1" = 20'

/RIGHT 2022, EMERALD CITY ENGINEERS, INC.

J:\2023-068 950 HOPPER, PETALUMA, CA\DWG\E102.DWG 05-02-2022 14:50





FLAG NOTES

NOT USED


PHOTOMETRICS PLAN

SITE

SCALE: 1" = 20'

1. EXTERIOR LIGHTING TO BE CONTROLLED VIA


2. STREET LIGHTING NOT INCLUDED IN PLAN/PHOTOMETRIC

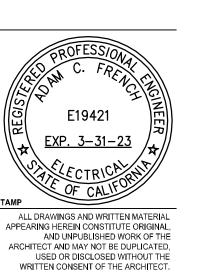

SITE LIGHTING **PHOTEMETRICS**

As indicated

E1.02

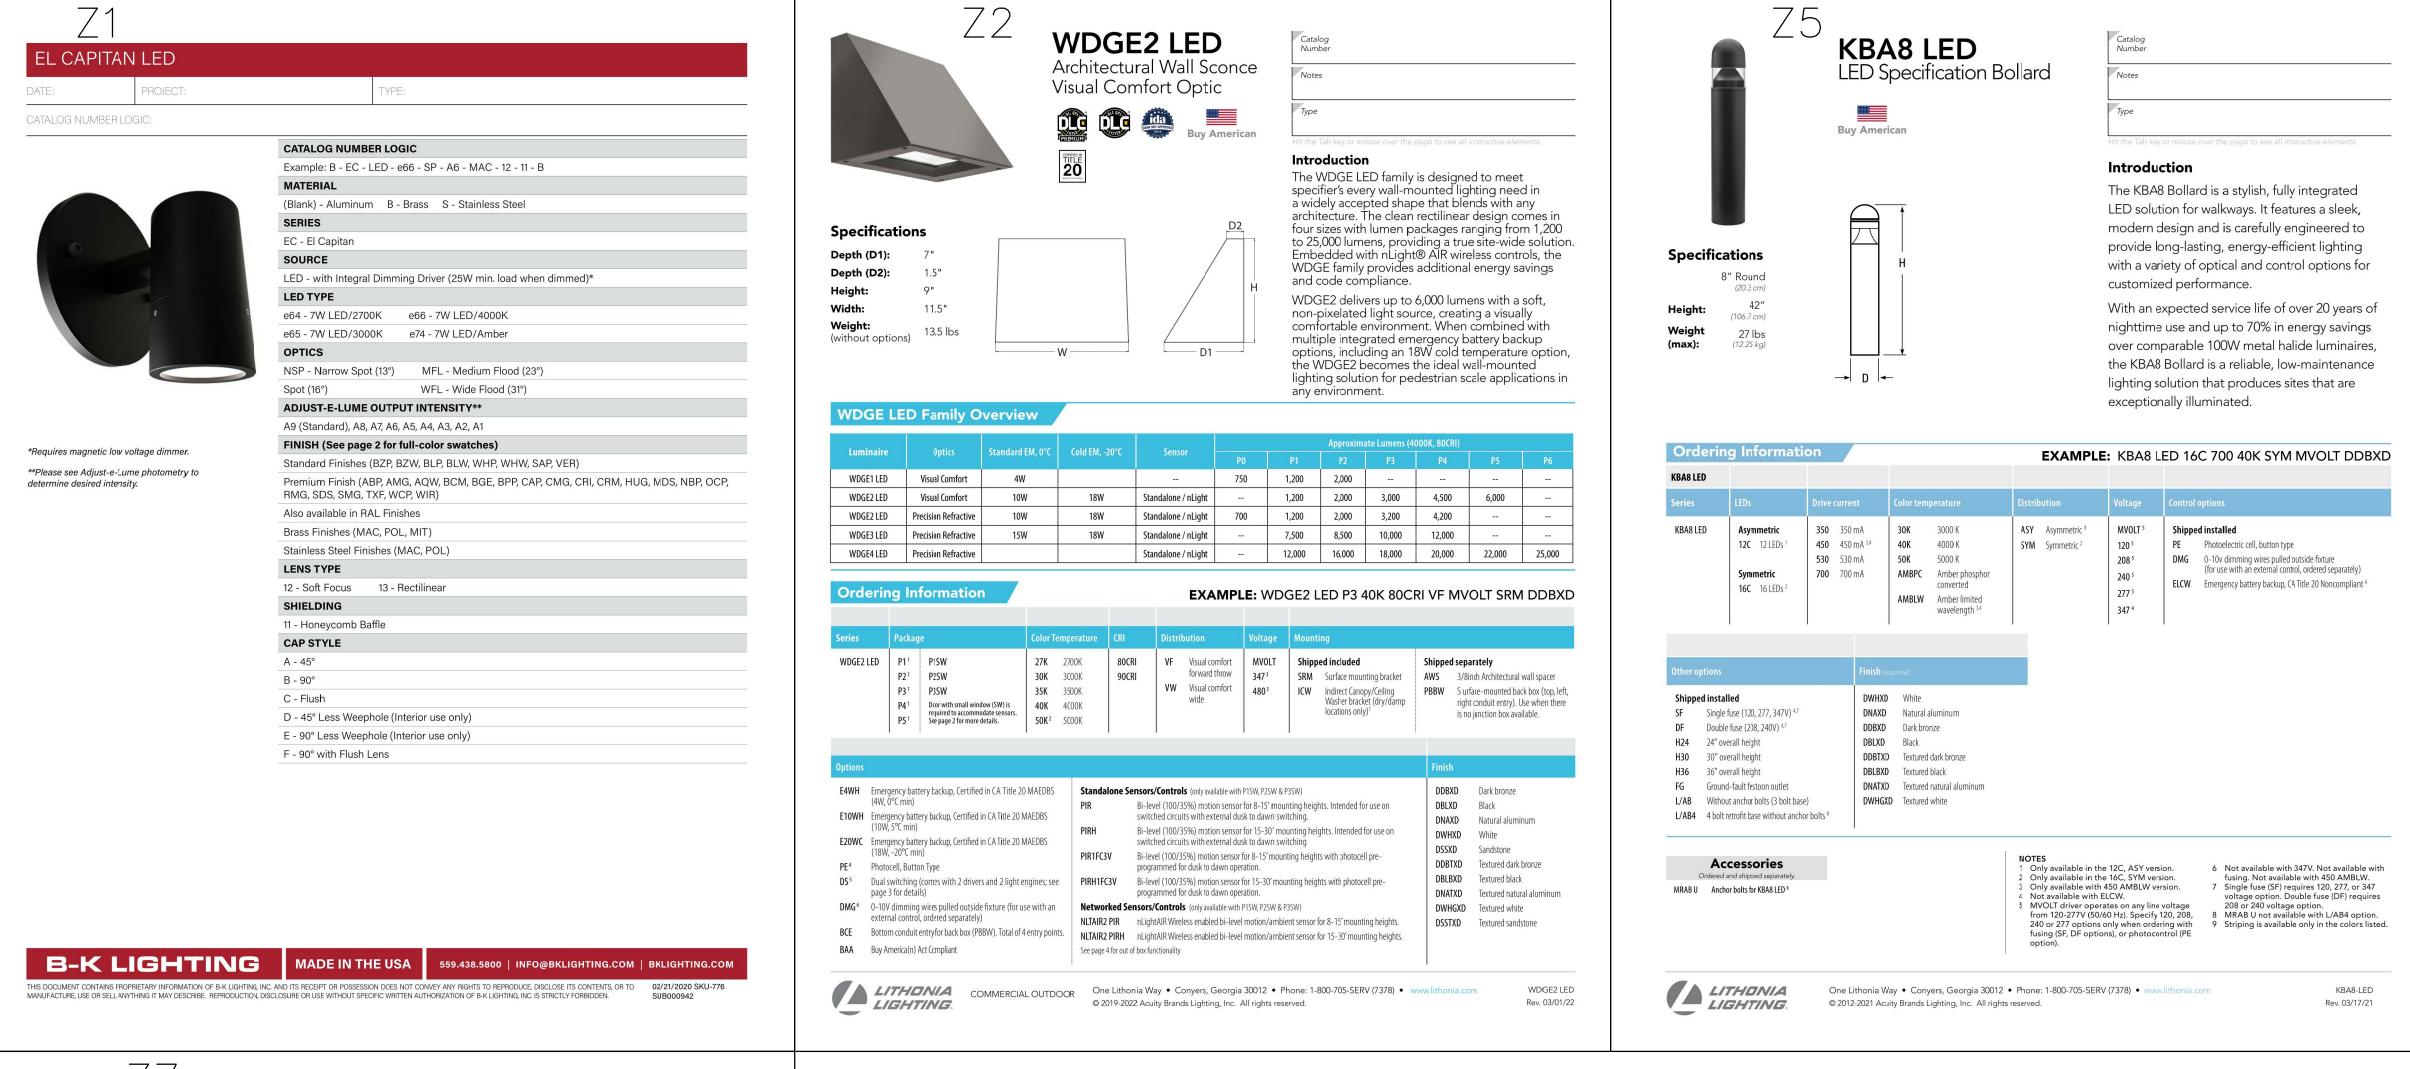




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950 HOWARD STREET SAN FRANCISCO CA 94103 P (415) 677-0966



500 HOPPER STREET PETALUMA, CA

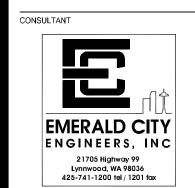REV ISSUE DATE



LUMINAIRE SCHEDULE

As indicated

U.# 2023-068 DRAWN BY AF/CL

GENERAL NOTES

- A. SITE PLAN IS FOR GENERAL BUILDING ORIENTATION AND ENLARGED PLAN REFERENCES.
- B. SEE JOINT TRENCH DRAWINGS FOR ON/OFF-SITE DRY UTILITY PLANS.
- C. SEE CIVIL DRAWINGS FOR ON/OFF-SITE UTILITY PLANS, IMPROVEMENTS, GRADING, DRAINAGE AND STORM WATER TREATMENT.
- D. SEE LANDSCAPE DRAWINGS FOR SITE FINE GRADING, PAVING PLAN, PLANTING PLAN, AND IRRIGATION PLAN.
- E. SEE A0.3X FOR BUILDING AREA CALCULATIONS.
- F. SEE A0.4X FOR EGRESS CALCULATIONS & DIAGRAMS. UNIT PLANS SHOWN HERE ARE DIAGRAMATIC REFER TO 1/4" UNIT PLANS AND ENLARGED PLANS FOR ADDITIONAL INFORMATION NOT SHOWN HERE.
- H. SPOT ELEVATIONS ARE NOTED FROM CIVIL DRAWINGS, XXX' = 0'-0".
- MINIMUM SLOPE AT FLAT ROOF SHALL BE 3/8"/FT,
- REFER TO THE 1/8" AND 1/4" PLANS FOR THE DOOR TAGS. REFER TO DOOR SCHEDULE INDICATING ALL REQUIRED RATED DOOR LOCATIONS.
- K. AT THE TIME OF FOUNDATION INSPECTION CORNER STAKES OR OFFSET STAKES MUST BE ESTABLISHED BY A LAND SURVEYOR REGISTERED IN THE STATE OF CALIFORNIA AND VERIFIED BY THE FIELD INSPECTOR

TO ENSURE THAT NEW CONSTRUCTION IS LOCATED IN ACCORDANCE WITH THE APPROVED PLANS.

WALKWAYS AND SIDEWALKS ALONG ACCESSIBLE ROUTES OF TRAVEL SHALL BE (1) CONTINUOUSLY ACCESSIBLE; (2) HAVE A MAXIMUM 1/2" CHANGES IN ELEVATION, OR PROVIDE CURB RAMPS COMPLYING WITH CBC 1112A OR 11B-406; (3) ARE MINIMUM 48" IN WIDTH; AND (4) WHERE NECESSARY TO CHANGE ELEVATION AT A SLOPE EXCEEDING 5% SHALL HAVE PEDESTRIAN RAMPS COMPLYING WITH CBC 1114A OR 11B-405; PER CBC 1113A & 11B-202.4

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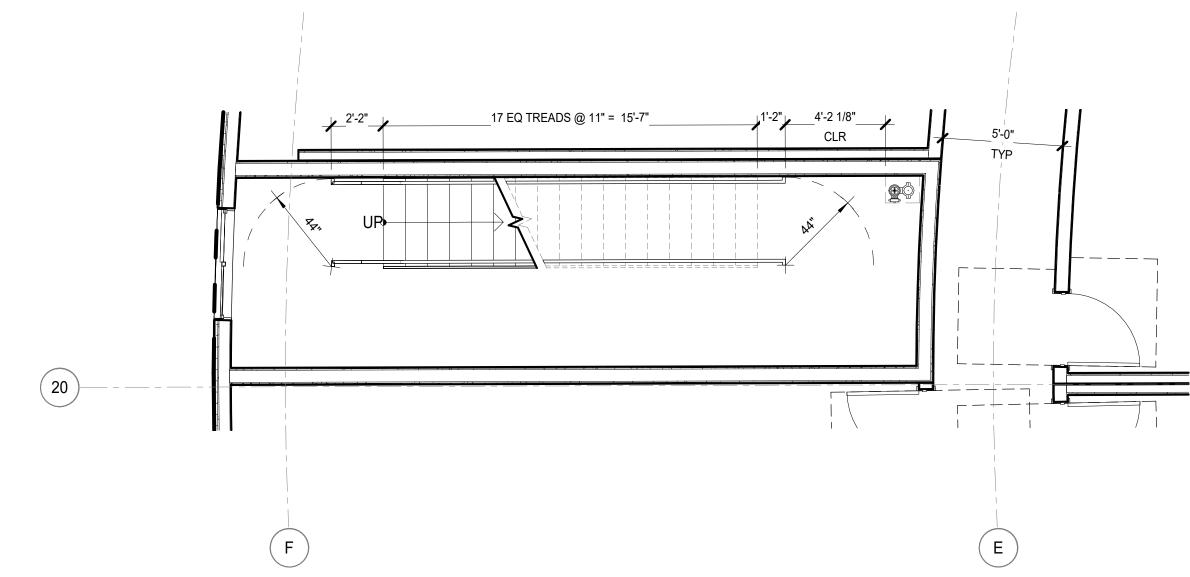
LIVING GROUP

PLANNING 6.6.22 RESUBMITTA L 1


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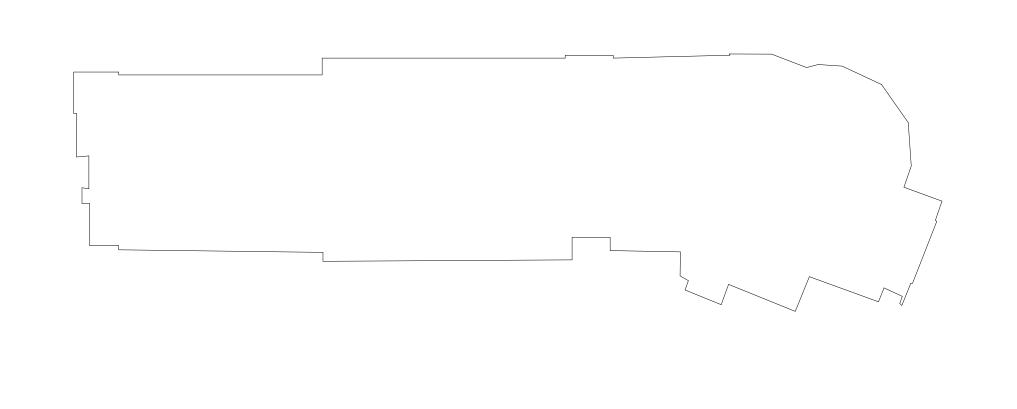
SITE PLAN -FLOOR 1


SCALE: As indicated PROJ #. 2110 DRAWN BY: XX SHEET SIZE: 30 x 42



SINGLE RUN STAIR - TYPICAL 2



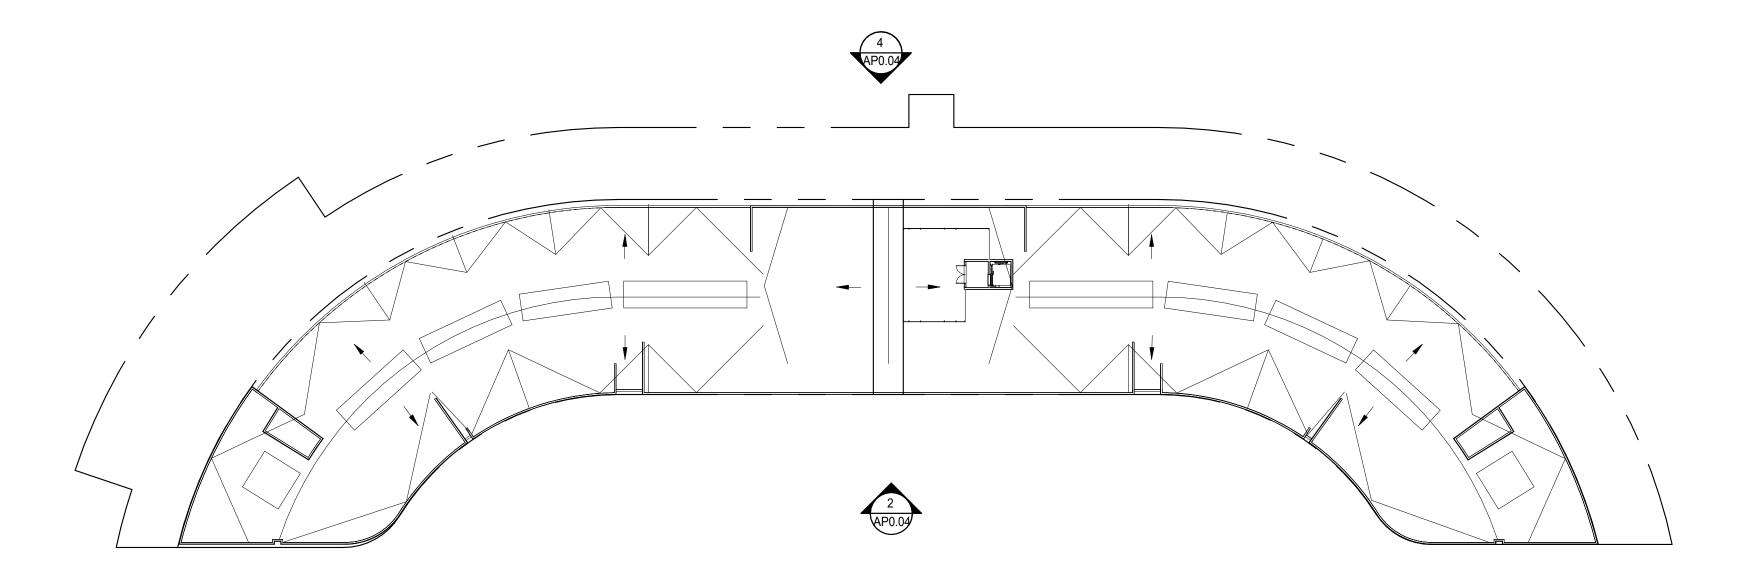

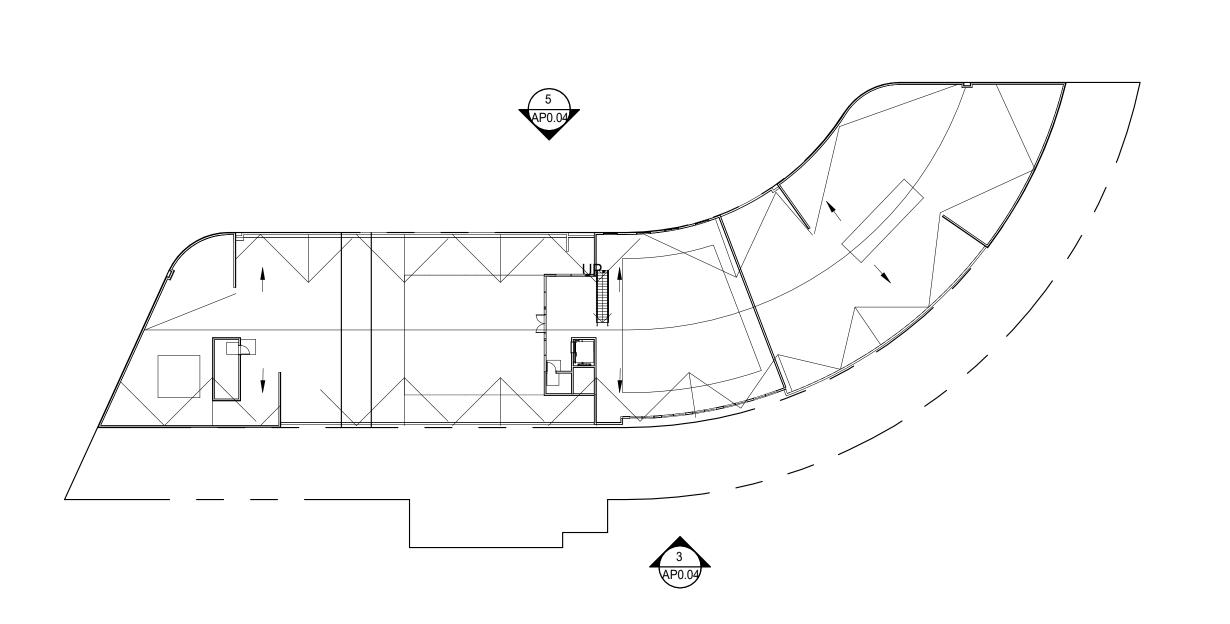

GENERAL NOTES

- A. SITE PLAN IS FOR GENERAL BUILDING ORIENTATION AND ENLARGED PLAN REFERENCES.
- B. SEE JOINT TRENCH DRAWINGS FOR ON/OFF-SITE DRY UTILITY PLANS.
- C. SEE CIVIL DRAWINGS FOR ON/OFF-SITE UTILITY PLANS, IMPROVEMENTS, GRADING, DRAINAGE AND STORM WATER TREATMENT.
- D. SEE LANDSCAPE DRAWINGS FOR SITE FINE GRADING, PAVING PLAN, PLANTING PLAN, AND IRRIGATION PLAN.
- E. SEE A0.3X FOR BUILDING AREA CALCULATIONS.
- F. SEE A0.4X FOR EGRESS CALCULATIONS & DIAGRAMS.
- UNIT PLANS SHOWN HERE ARE DIAGRAMATIC REFER TO 1/4" UNIT PLANS AND ENLARGED PLANS FOR ADDITIONAL INFORMATION NOT SHOWN HERE.
- H. SPOT ELEVATIONS ARE NOTED FROM CIVIL DRAWINGS, XXX' = 0'-0".
- I. MINIMUM SLOPE AT FLAT ROOF SHALL BE 3/8"/FT, U.O.N.
- J. REFER TO THE 1/8" AND 1/4" PLANS FOR THE DOOR TAGS. REFER TO DOOR SCHEDULE INDICATING ALL REQUIRED RATED DOOR LOCATIONS.
- K. AT THE TIME OF FOUNDATION INSPECTION CORNER STAKES OR OFFSET STAKES MUST BE ESTABLISHED BY A LAND SURVEYOR REGISTERED IN THE STATE OF CALIFORNIA AND VERIFIED BY THE FIELD INSPECTOR TO ENSURE THAT NEW CONSTRUCTION IS LOCATED IN ACCORDANCE WITH THE APPROVED PLANS.
- L. WALKWAYS AND SIDEWALKS ALONG ACCESSIBLE ROUTES OF TRAVEL SHALL BE (1) CONTINUOUSLY ACCESSIBLE; (2) HAVE A MAXIMUM 1/2" CHANGES IN ELEVATION, OR PROVIDE CURB RAMPS COMPLYING WITH CBC 1112A OR 11B-406; (3) ARE MINIMUM 48" IN WIDTH; AND (4) WHERE NECESSARY TO CHANGE ELEVATION AT A SLOPE EXCEEDING 5% SHALL HAVE PEDESTRIAN RAMPS COMPLYING WITH CBC 1114A OR 11B-405; PER CBC 1113A & 11B-202.4

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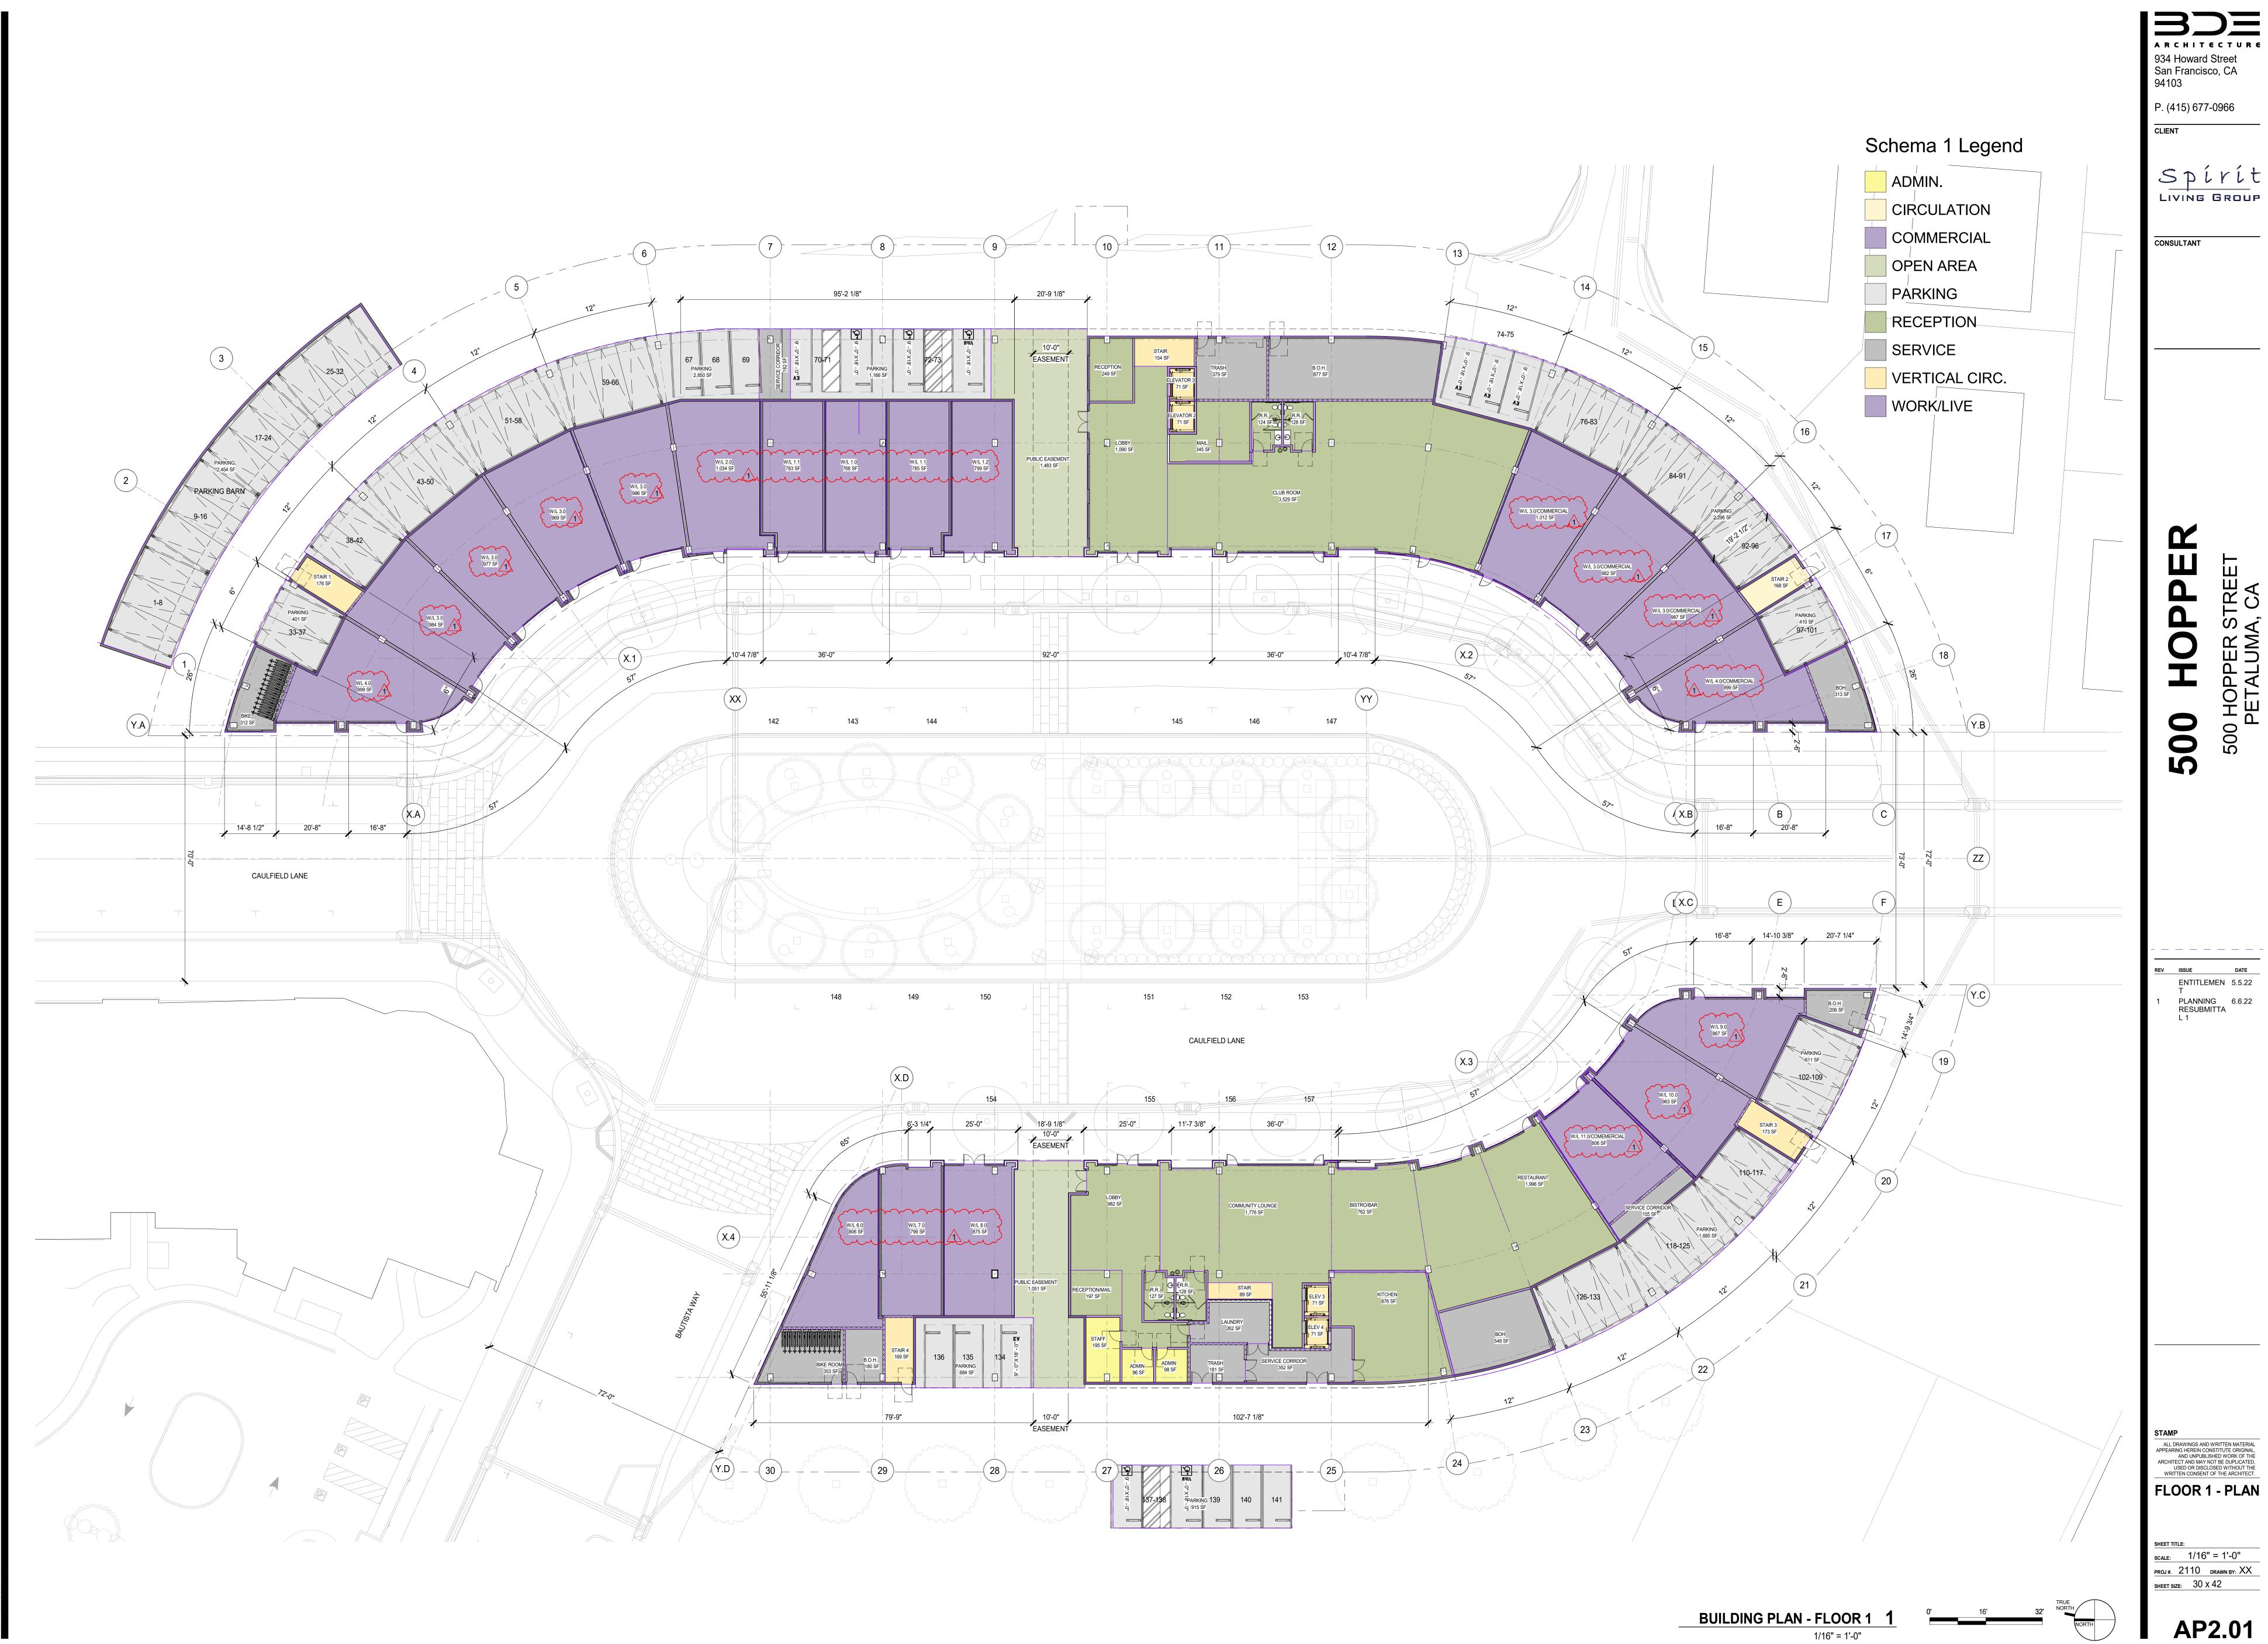
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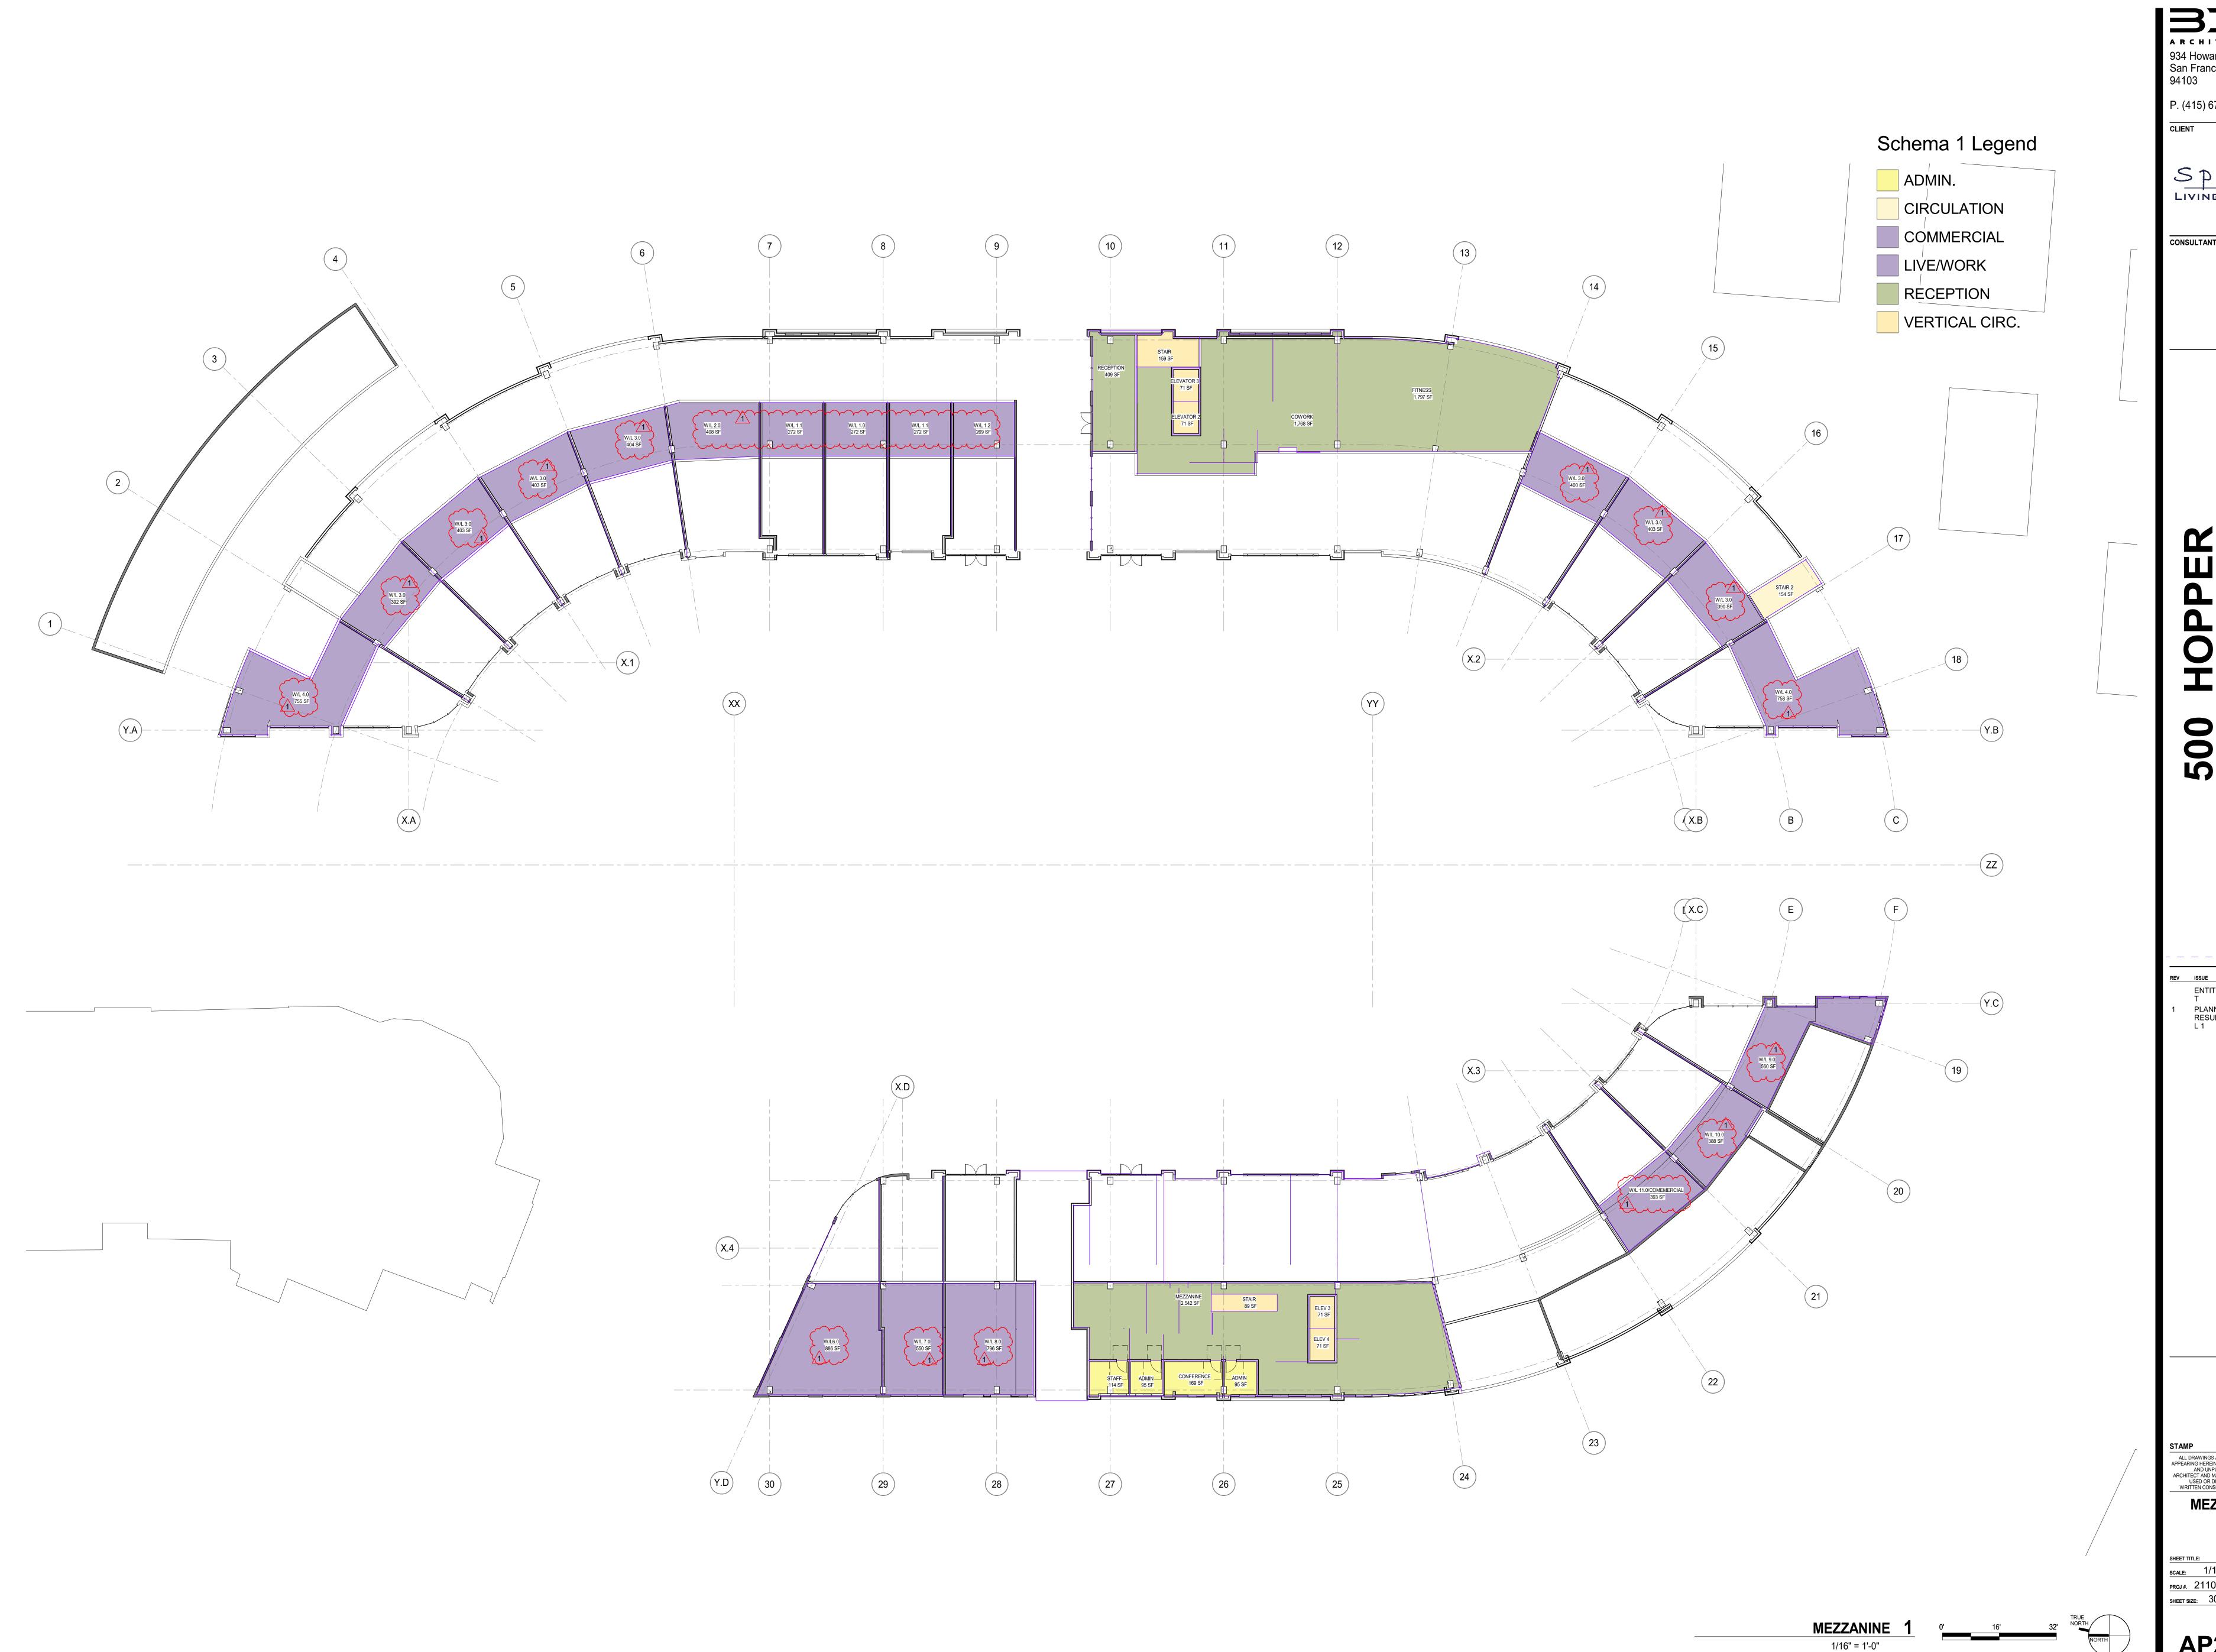
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SITE PLAN -**ROOF PLAN & ELEVATION** SHEET STAIR PLANS scale: As indicated PROJ#. 2110 DRAWN BY: XX

1/32" = 1'-0"



ENTITLEMEN 5.5.22 PLANNING 6.6.22 RESUBMITTA L 1




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MEZZANINE -**PLAN**

SCALE: 1/16" = 1'-0" PROJ #. 2110 DRAWN BY: XX SHEET SIZE: 30 x 42




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FLOOR 2 - PLAN

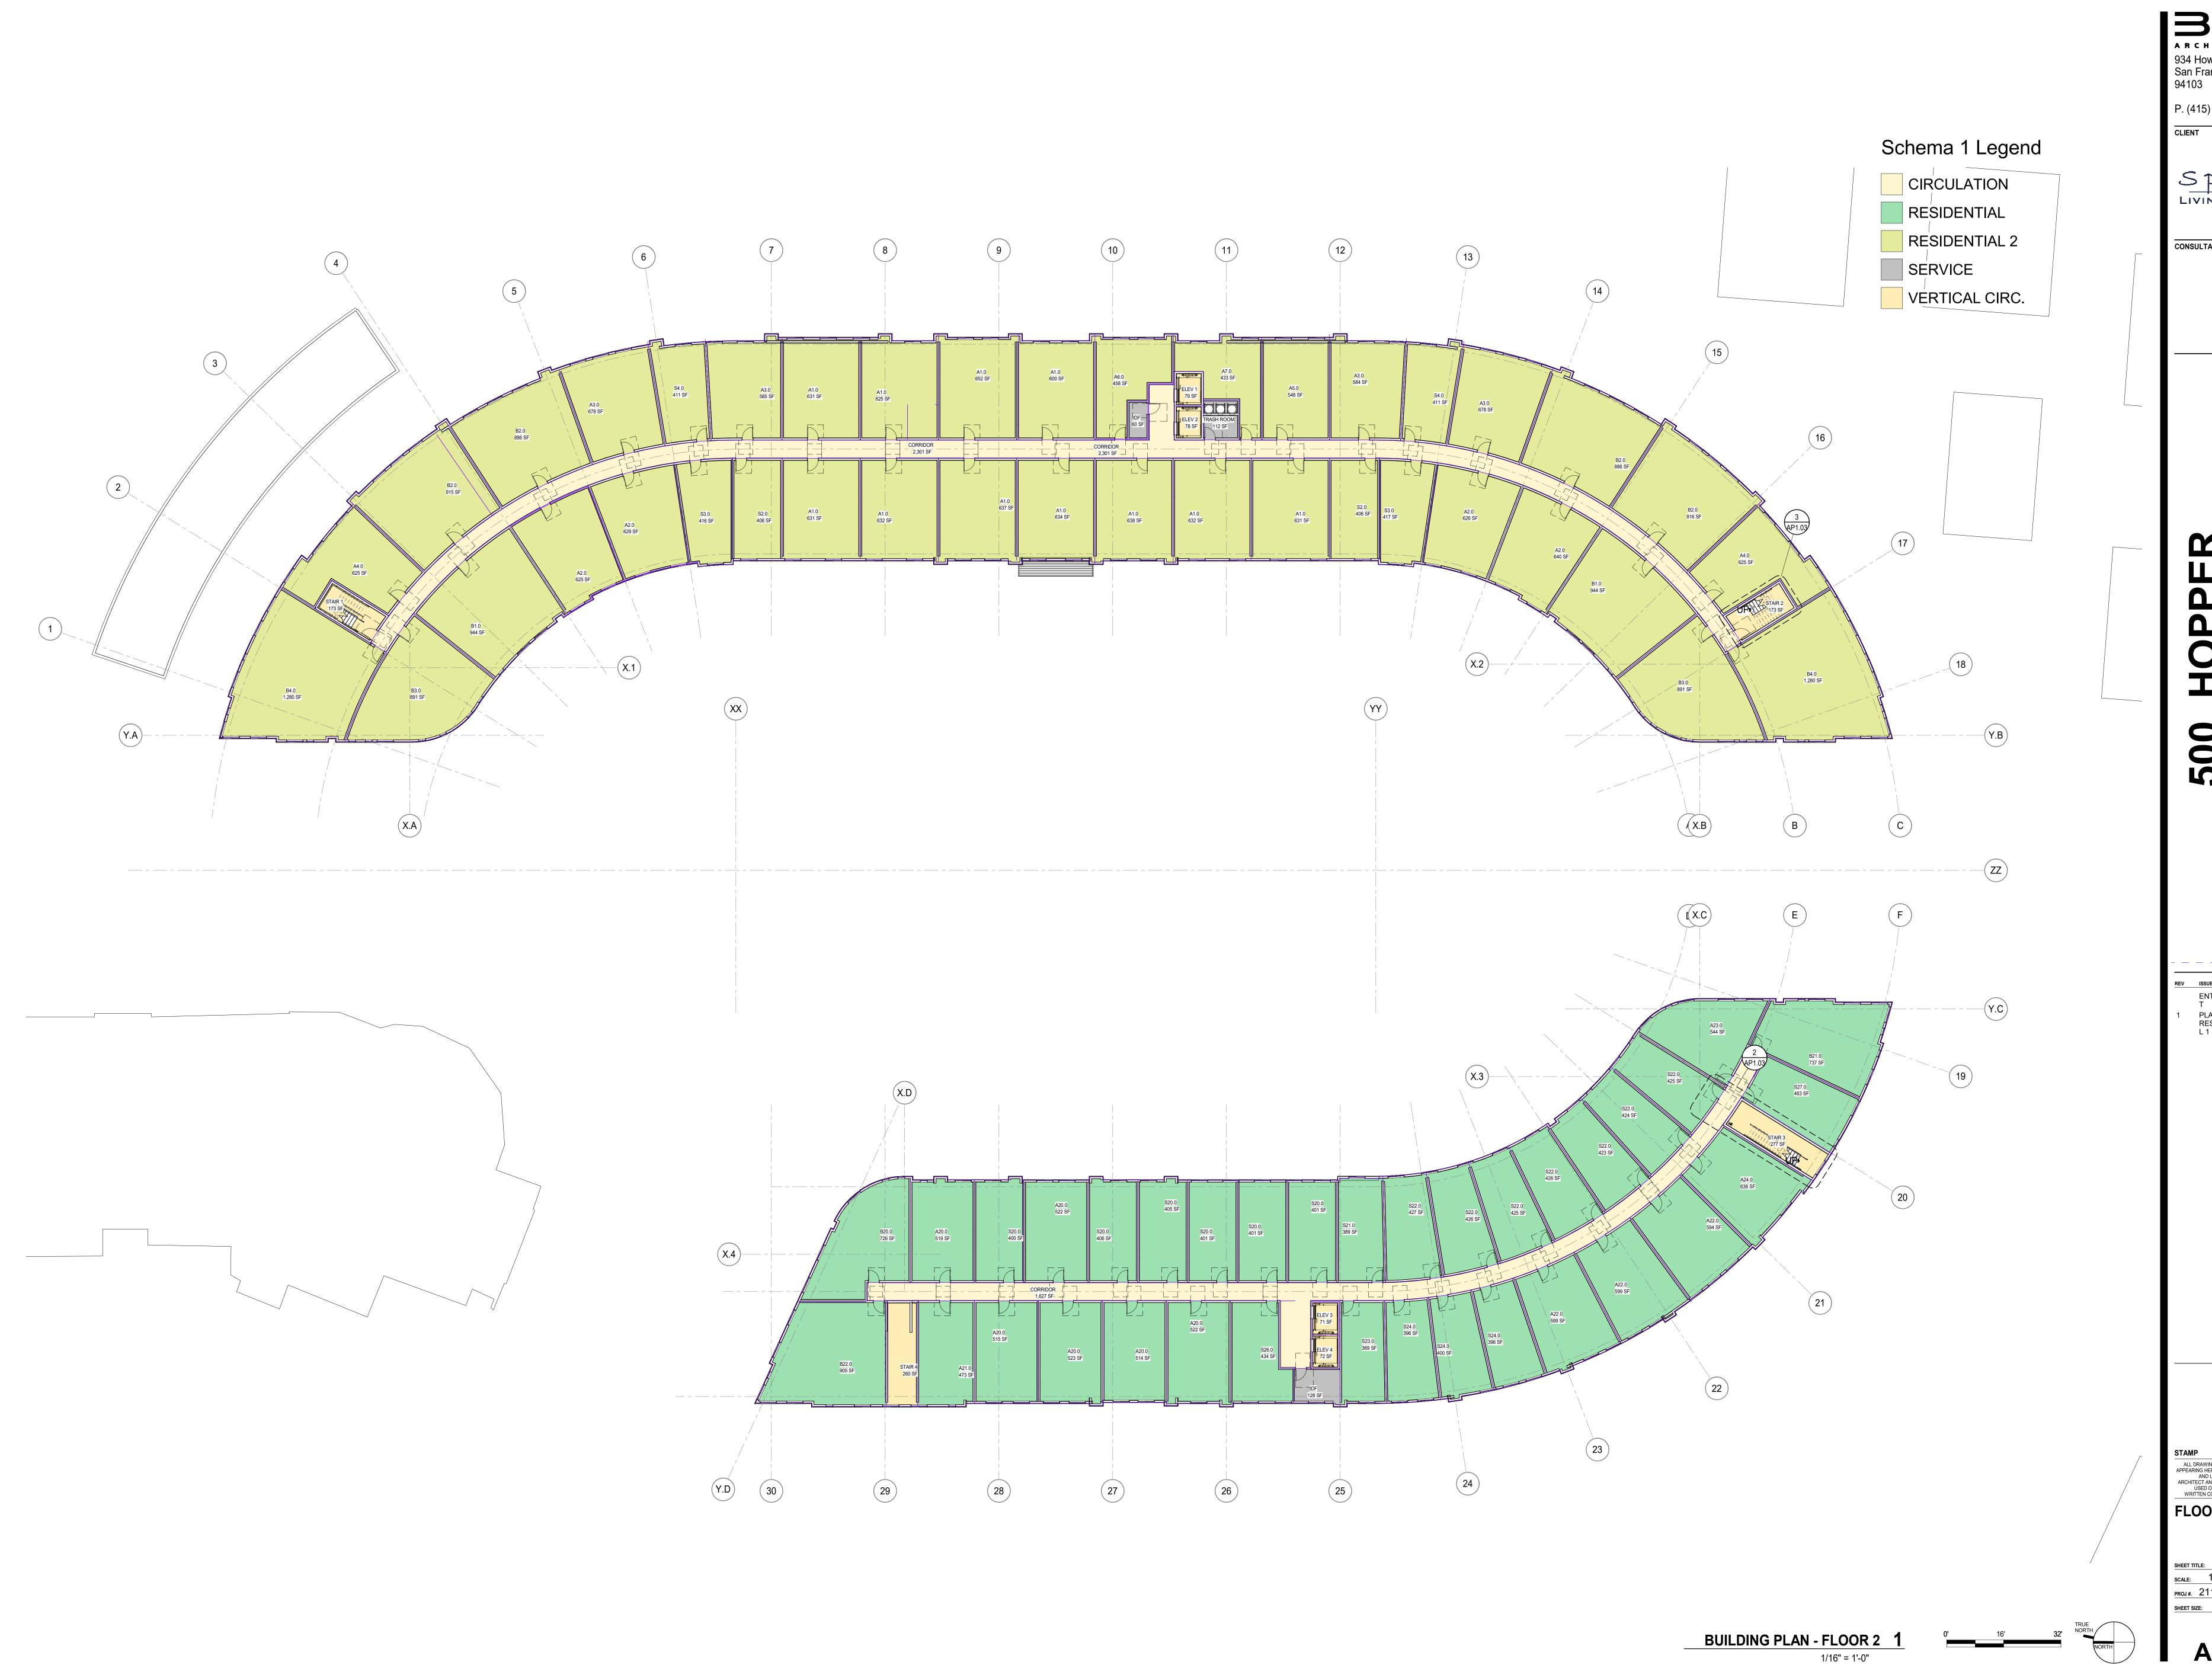SCALE: 1/16" = 1'-0"

PROJ #. 2110 DRAWN BY: XX SHEET SIZE: 30 x 42




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FLOOR 3 - PLAN

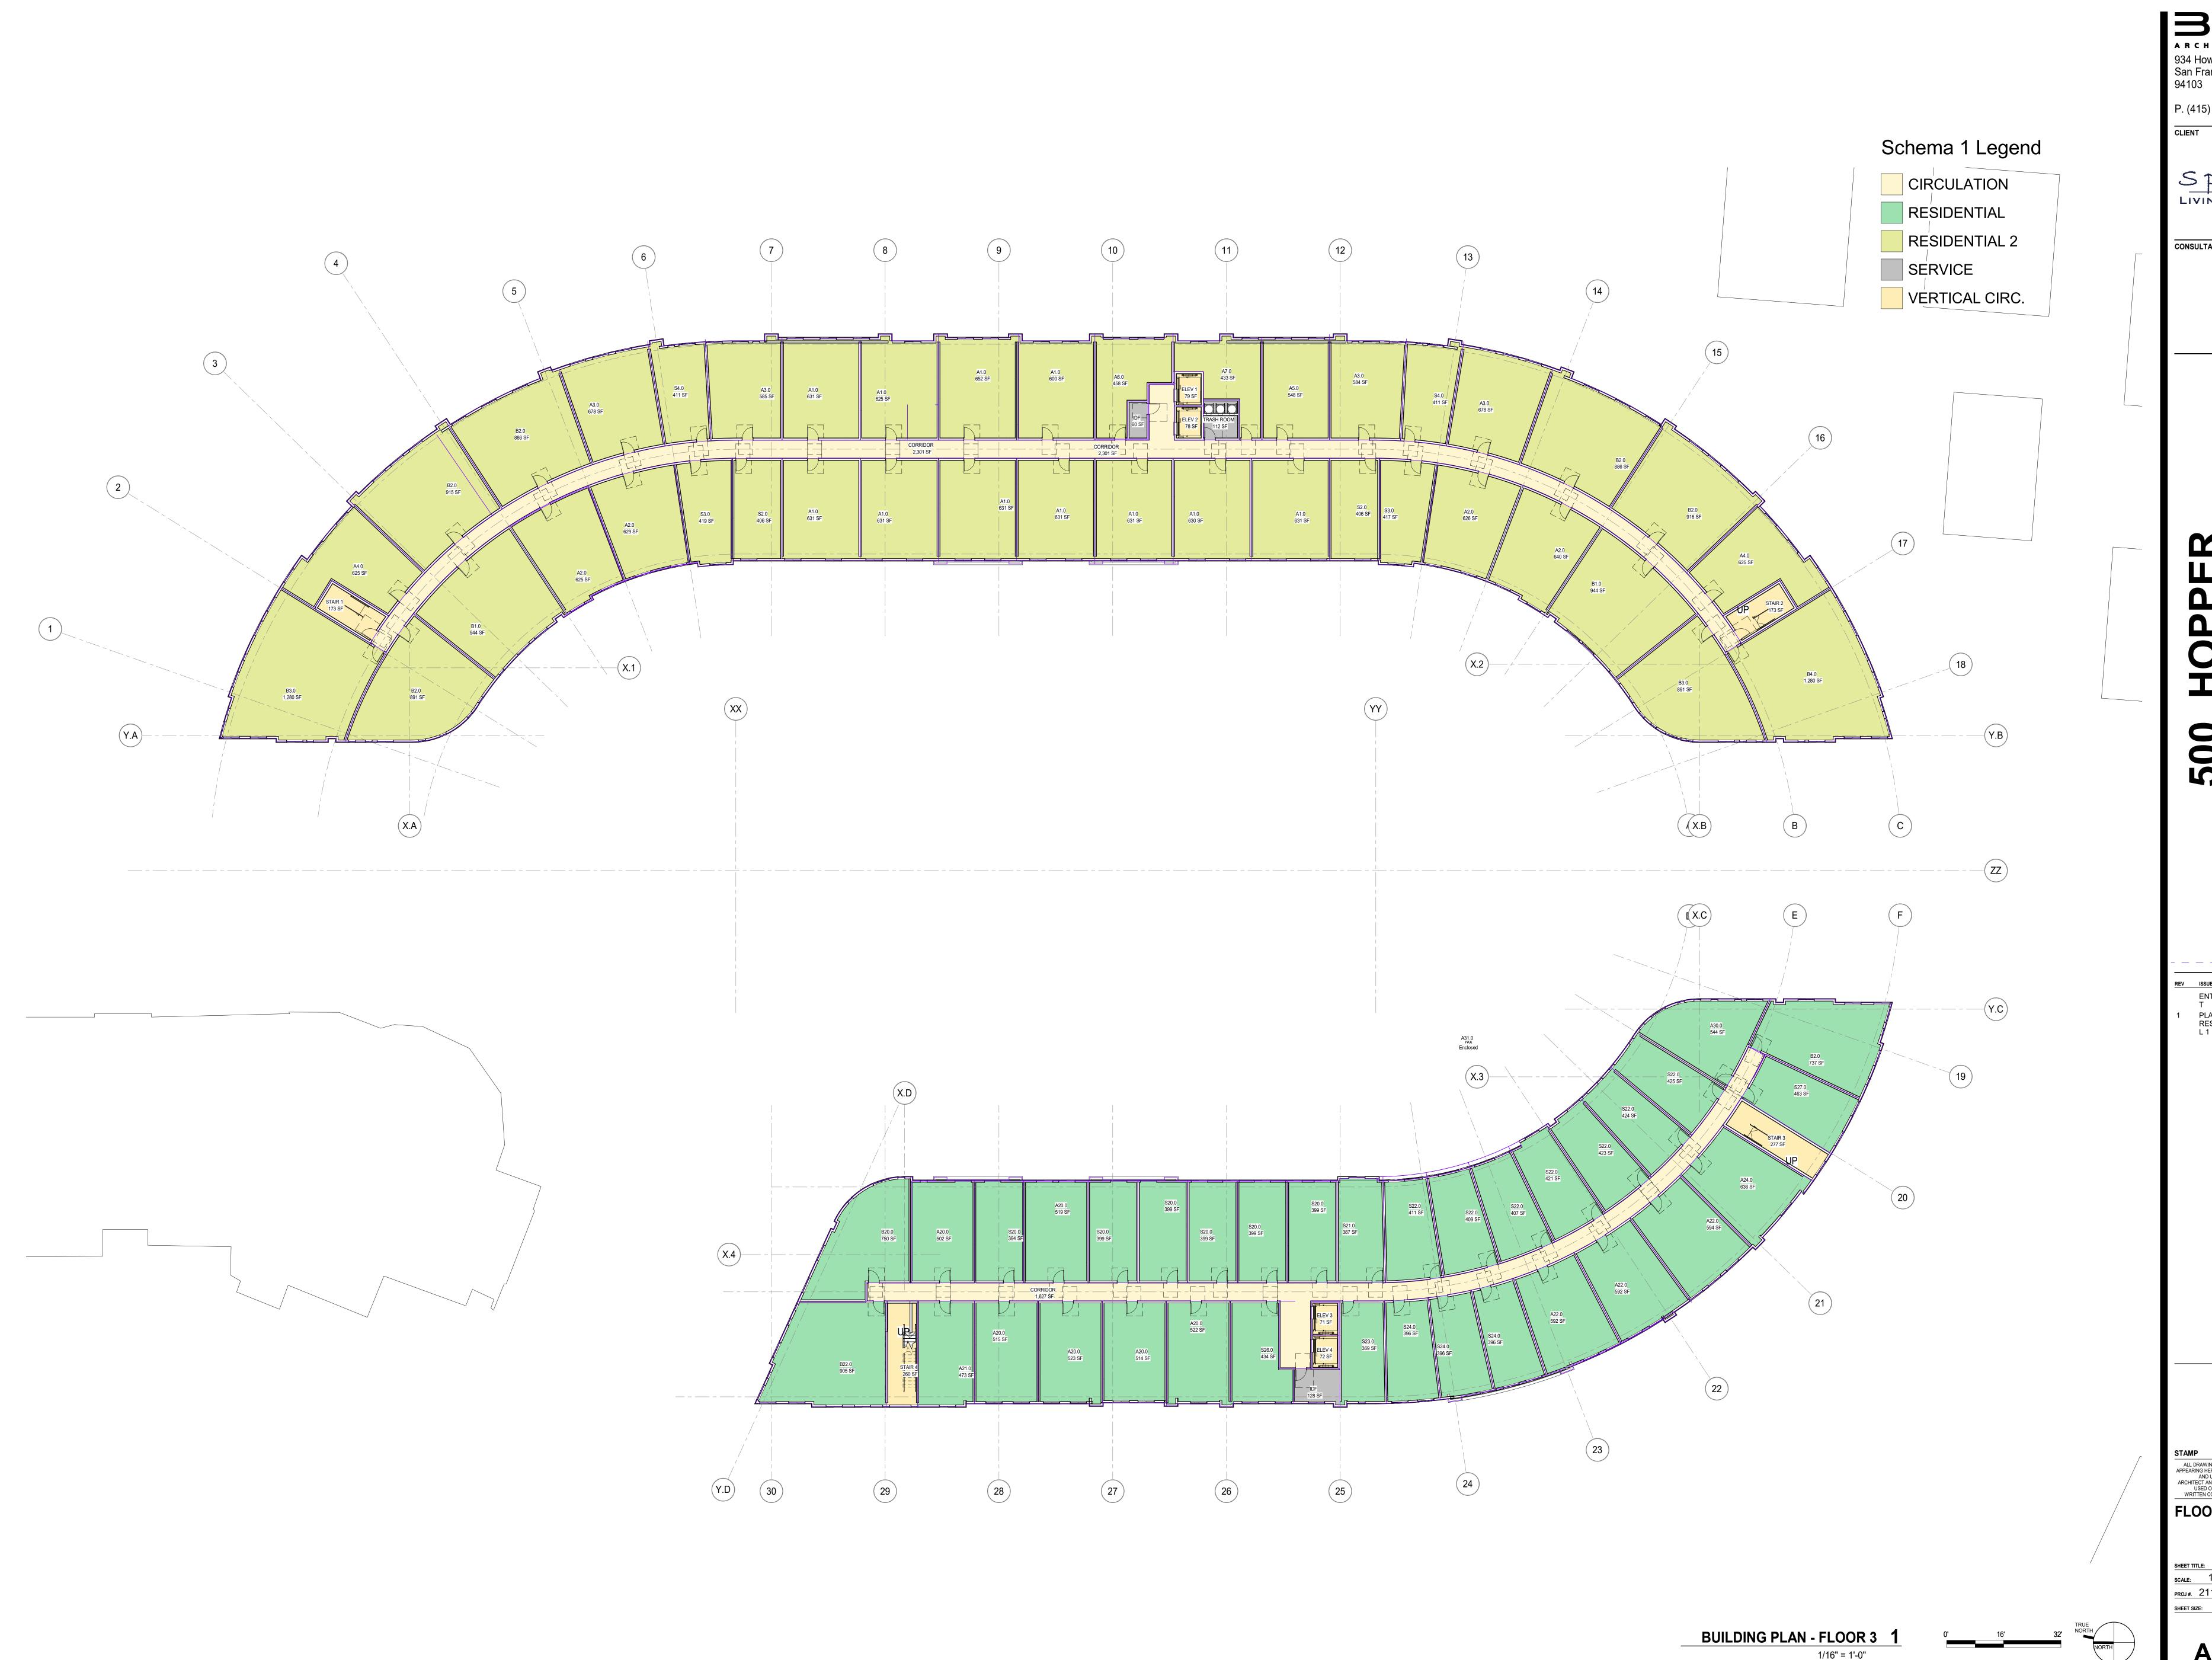SCALE: 1/16" = 1'-0" PROJ #. 2110 DRAWN BY: XX SHEET SIZE: 30 x 42




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FLOOR 4 - PLAN

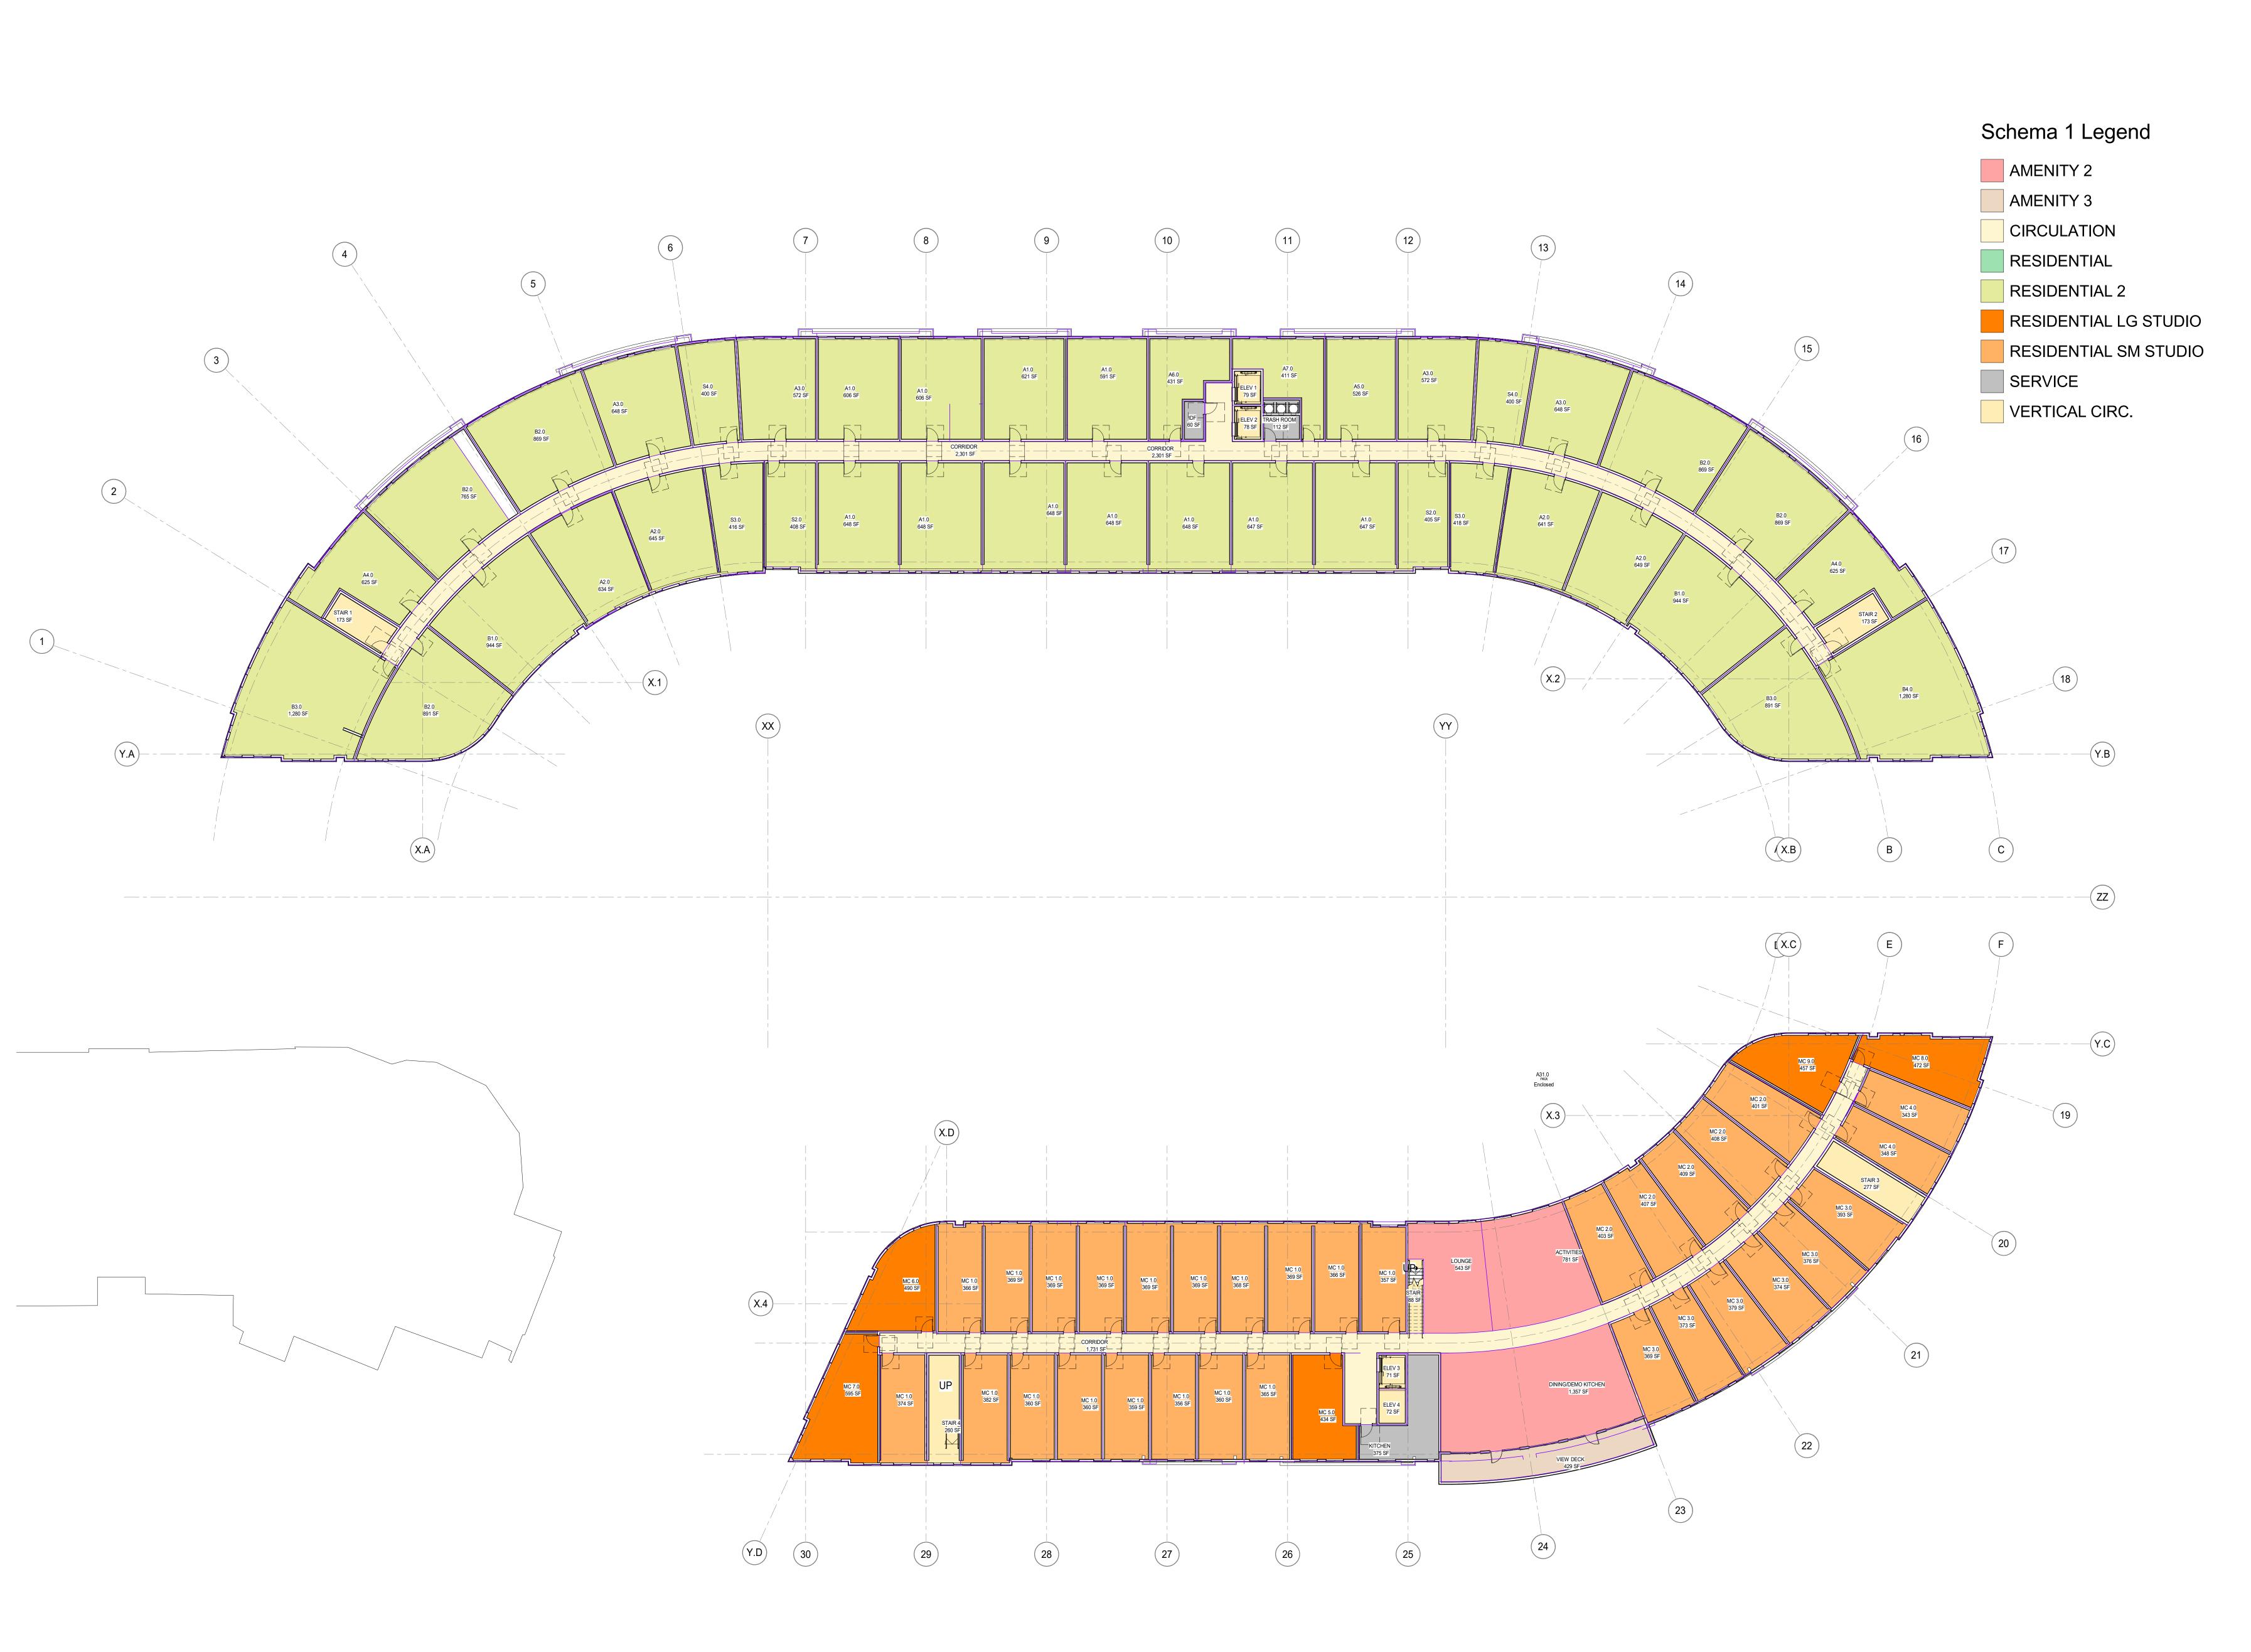SCALE: 1/16" = 1'-0" PROJ #. 2110 DRAWN BY: XX SHEET SIZE: 30 x 42



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PLANNING 6.6.22 RESUBMITTA L 1

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ROOF - PLAN

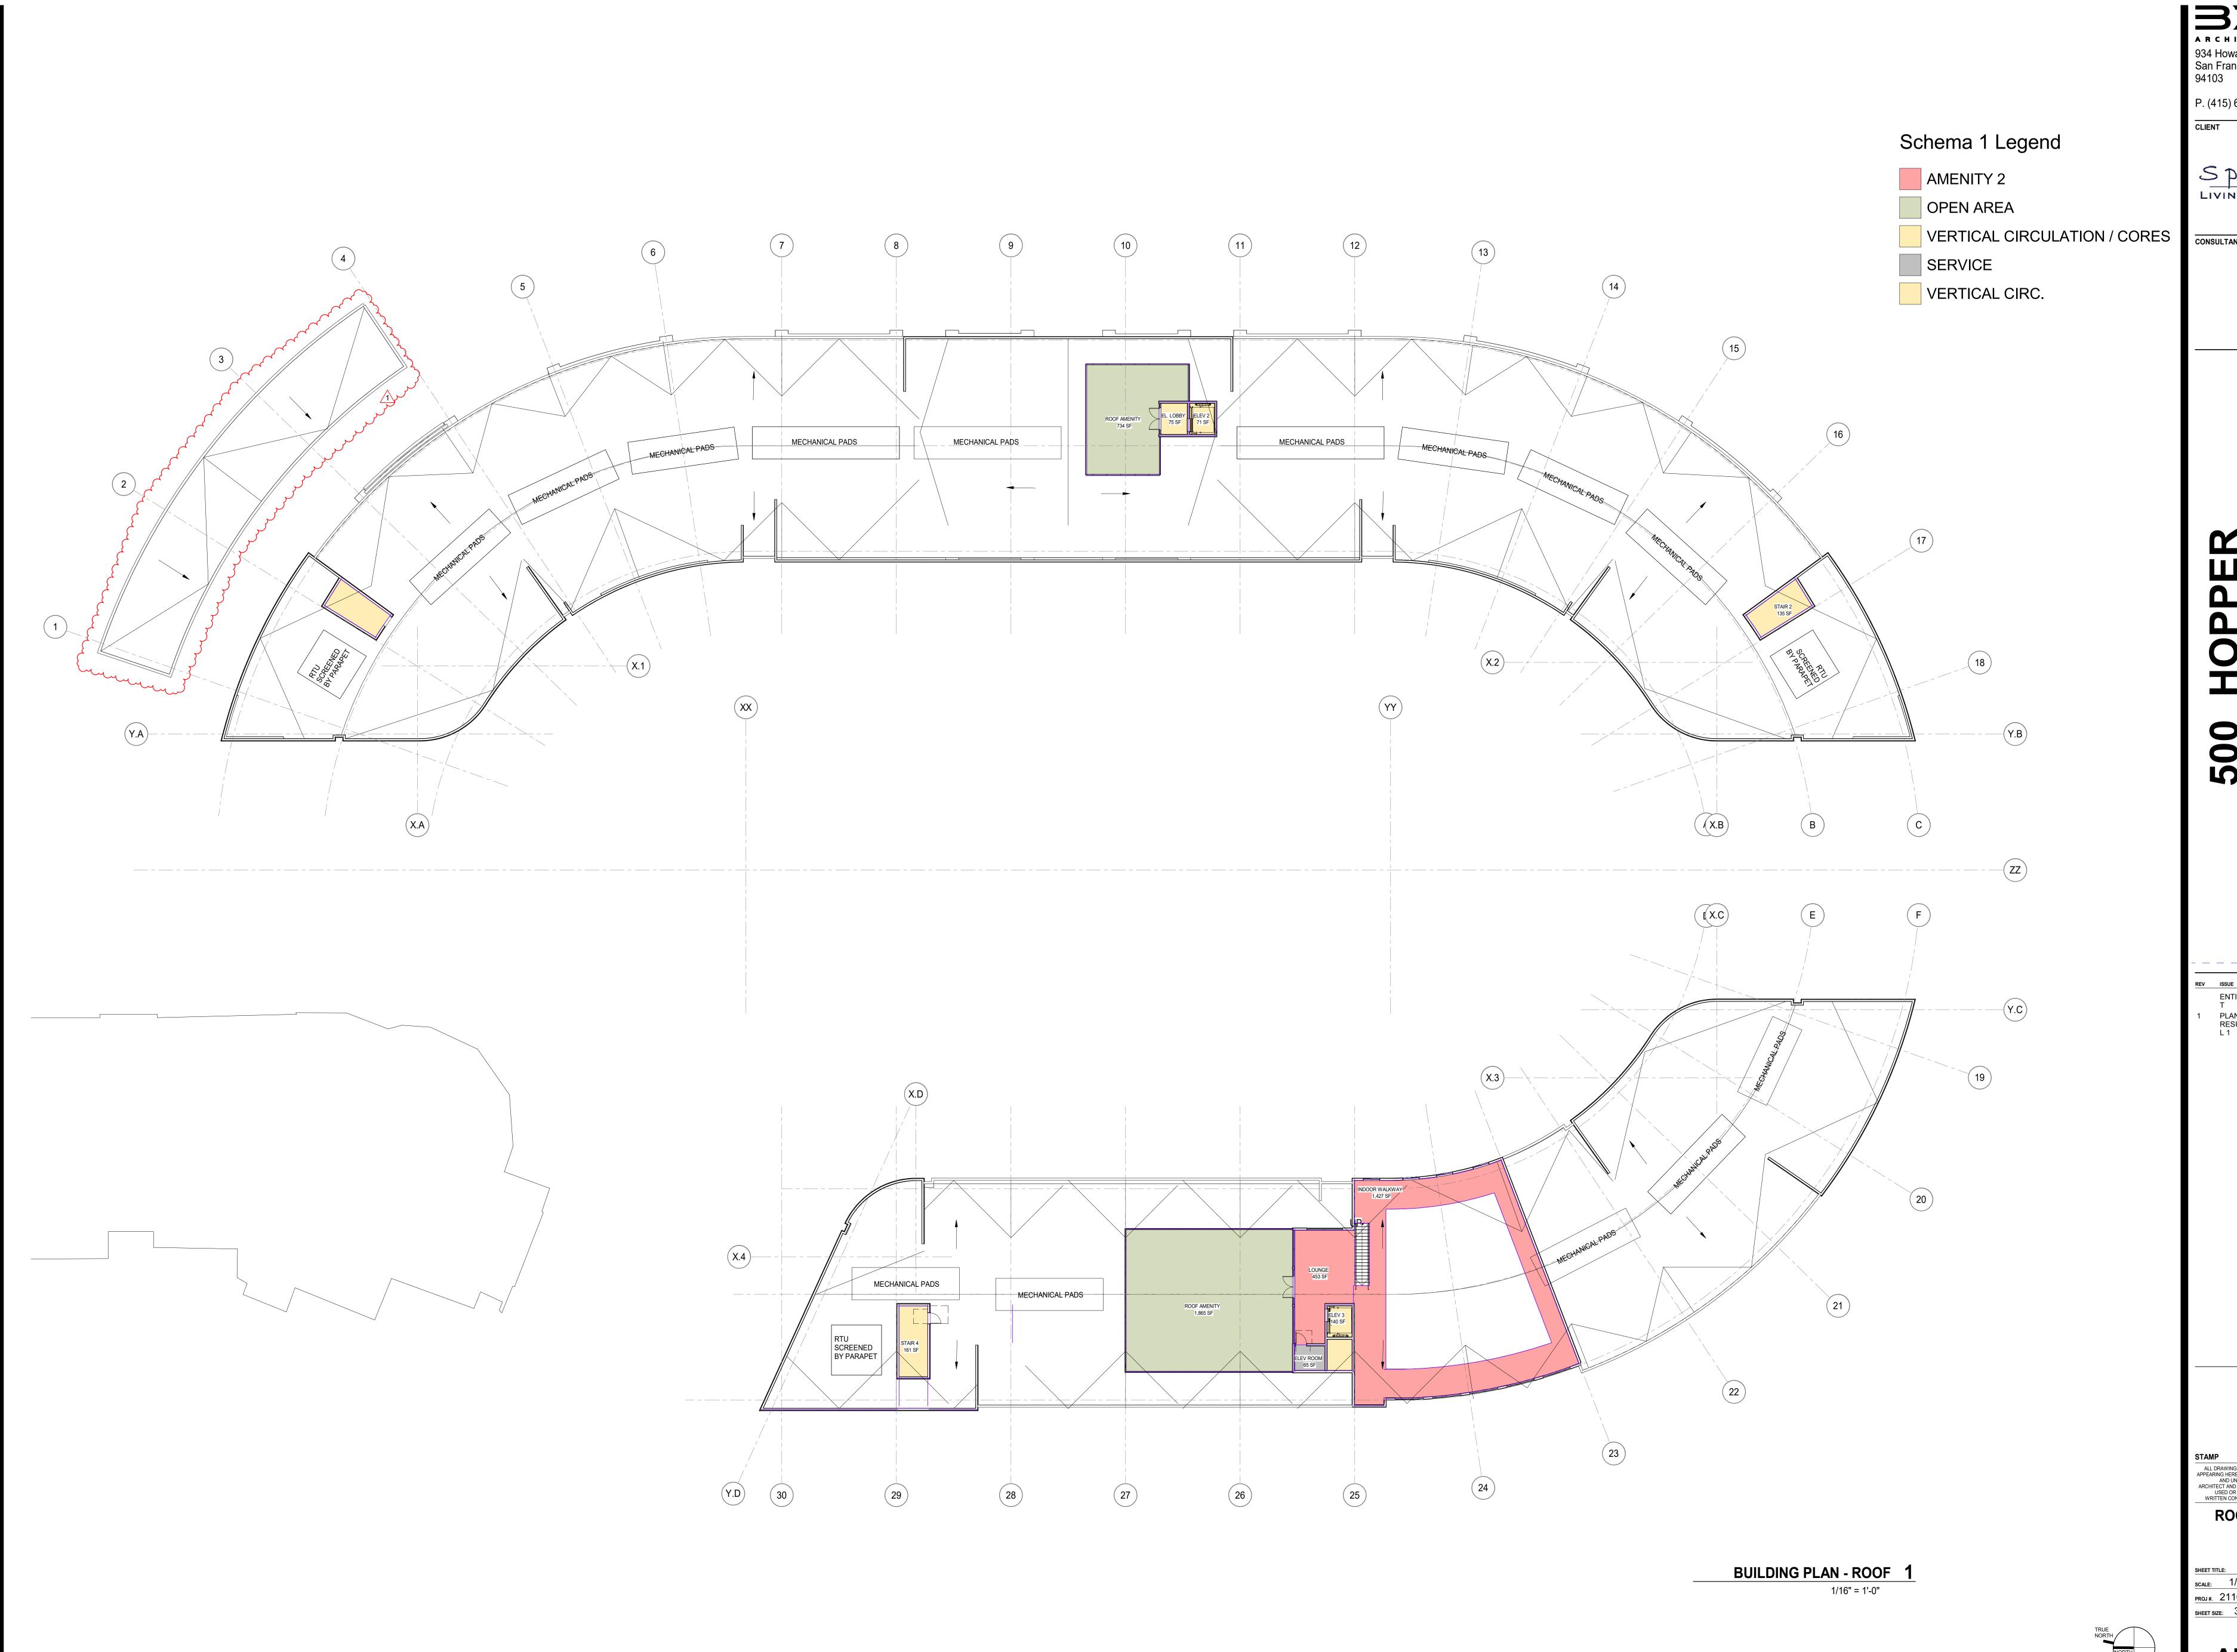
SCALE: 1/16" = 1'-0" PROJ#. 2110 DRAWN BAUTHOR SHEET SIZE: 30 x 42

Spírít LIVING GROUP

ENTITLEMEN 5.5.22 PLANNING 6.6.22 RESUBMITTA L 1

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SCALE: 1/16" = 1'-0" PROJ #. 2110 DRAWN BY: XX SHEET SIZE: 30 x 42

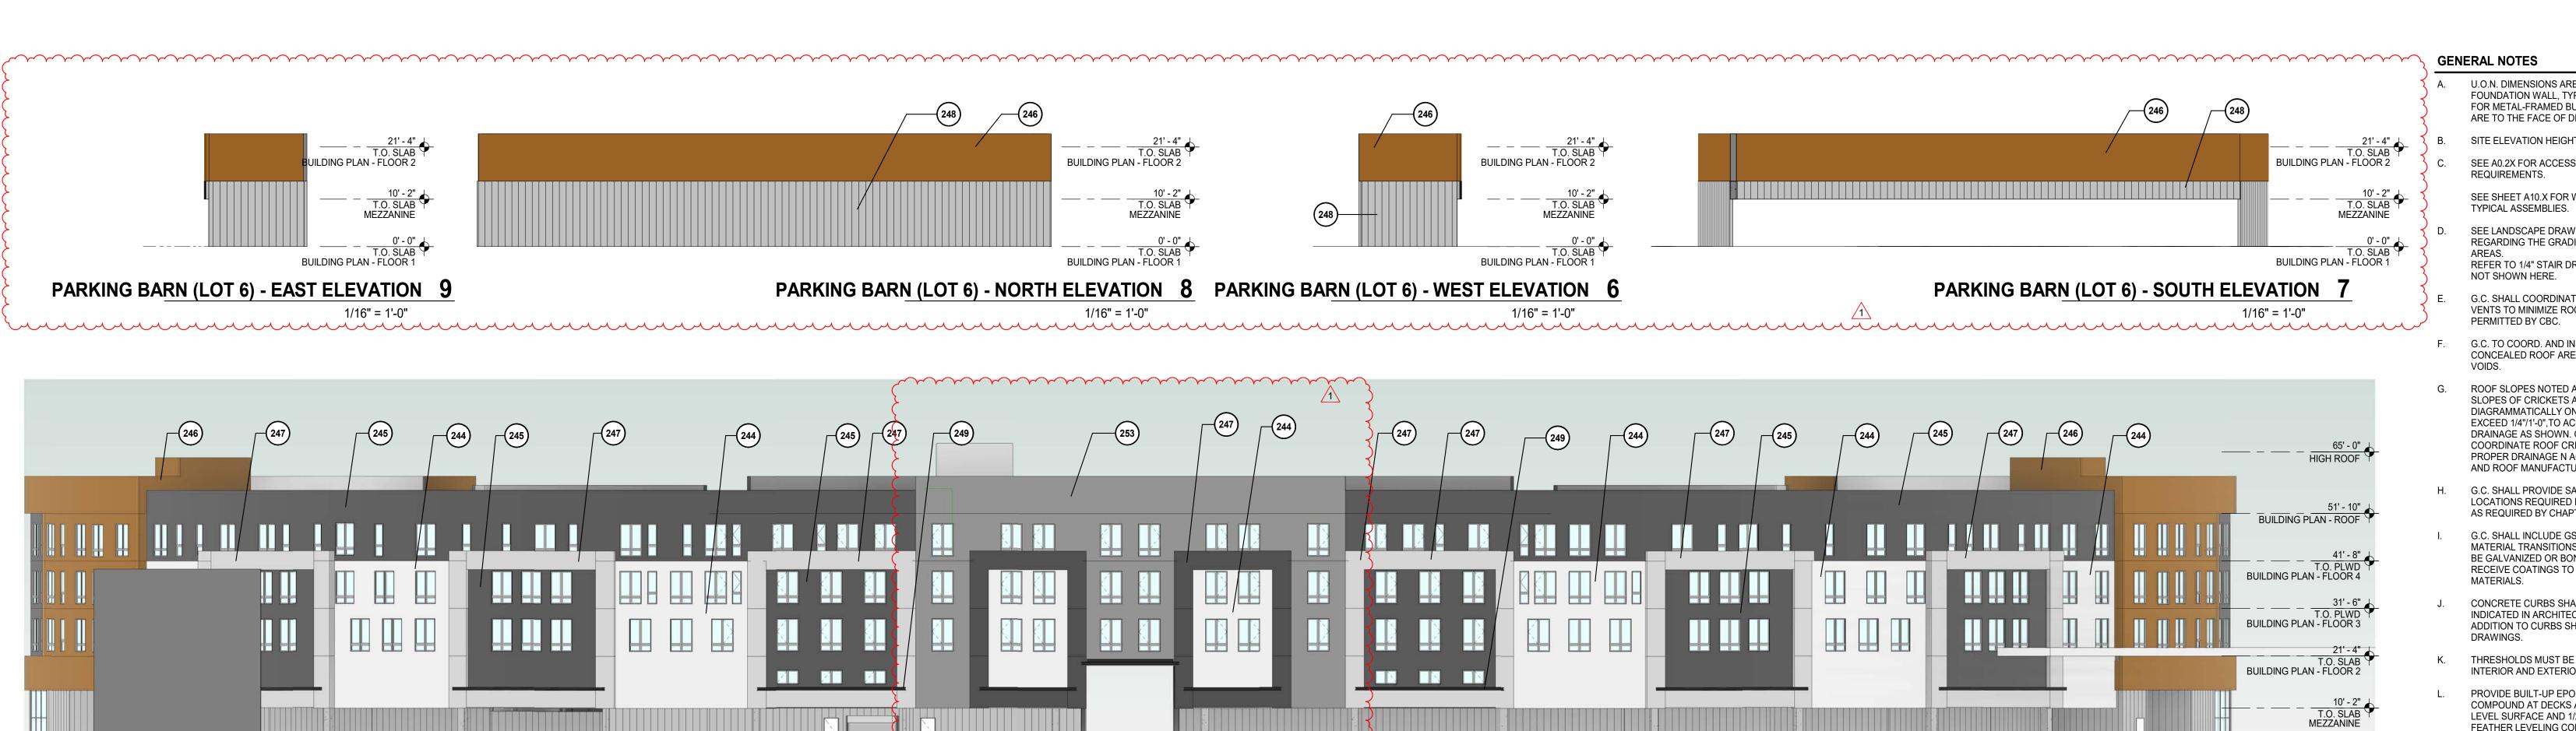

BUILDING 1 (LOT 6) - EAST ELEVATION 4

1/16" = 1'-0"

BUILDING PLAN - FLOOR 1



BUILDING 1 (LOT 6) - NORTH ELEVATION 3


65' - 0" HIGH ROOF ____ BUILDING PLAN - ROOF BUILDING PLAN - FLOOR 4 **BUILDING PLAN - FLOOR 3** 21' - 4"
T.O. SLAB
BUILDING PLAN - FLOOR 2 250 0' - 0"
T.O. SLAB
BUILDING PLAN - FLOOR 1

BUILDING 1 (LOT 6) - SOUTH ELEVATION 2



BUILDING 1 (LOT 6) - WEST ELEVATION 1

1/16" = 1'-0"

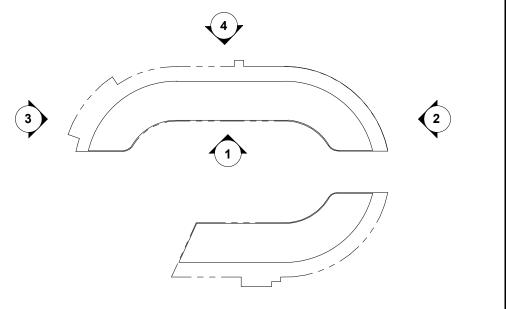

GENERAL NOTES

- A. U.O.N. DIMENSIONS ARE TO FACE OF STUD OR FOUNDATION WALL, TYP. (FOR TYPE III OR TYPE V) FOR METAL-FRAMED BUILDINGS THE DIMENSIONS ARE TO THE FACE OF DRYWALL.
- SITE ELEVATION HEIGHT OF XXX.XX' = 0'-0" DATUM. SEE A0.2X FOR ACCESSIBILITY AND ADAPTABILITY

ARCHITECTURE

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- REQUIREMENTS. SEE SHEET A10.X FOR WALL TYPE SCHEDULE AND
- SEE LANDSCAPE DRAWINGS FOR INFORMATION REGARDING THE GRADING OF ALL EXTERIOR REFER TO 1/4" STAIR DRAWINGS FOR INFORMATION NOT SHOWN HERE.
- G.C. SHALL COORDINATE PLUMBING & MECHANICAL VENTS TO MINIMIZE ROOF PENETRATIONS AS
- G.C. TO COORD. AND INSTALL VENTING FOR ALL CONCEALED ROOF AREAS AND OTHER FRAMED VOIDS.
- ROOF SLOPES NOTED ARE MINIMUMS. ROOF SLOPES OF CRICKETS ARE SHOWN DIAGRAMMATICALLY ON ROOF PLANS AND MAY EXCEED 1/4"/1'-0",TO ACHIEVE PROPER ROOF DRAINAGE AS SHOWN. G.C. TO INCLUDE AND COORDINATE ROOF CRICKETS IN FIELD FOR PROPER DRAINAGE N ACCORDANCE WITH CODE AND ROOF MANUFACTURER'S WARRANTY.
- H. G.C. SHALL PROVIDE SAFETY GLAZING IN ALL LOCATIONS REQUIRED BY CBC SECTION 2406 AND AS REQUIRED BY CHAPTER 7.
- G.C. SHALL INCLUDE GSM FLASHING AT ALL MATERIAL TRANSITIONS. ALL GSM FLASHING SHALL BE GALVANIZED OR BONDERIZED AND PAINTED OR RECEIVE COATINGS TO MATCH SURROUNDING MATERIALS.
- CONCRETE CURBS SHALL BE INCLUDED AS INDICATED IN ARCHITECTURAL DRAWINGS IN ADDITION TO CURBS SHOWN ON STRUCTURAL DRAWINGS.
- THRESHOLDS MUST BE COMPLIANT AT ALL INTERIOR AND EXTERIOR DOORS, MAX 1/2" HEIGHT.
- PROVIDE BUILT-UP EPOXY GROUT LEVELING COMPOUND AT DECKS AS REQ'D TO PROVIDE LEVEL SURFACE AND 1/2" MAX THRESHOLD. FEATHER LEVELING COMPOUND INTO DECK SURFACE AT MAX. 2% SLOPE.
- THE G.C. SHALL INCLUDE IN THE GMP THE LABOR AND MATERIALS TO PROVIDE A COMPLETE COLD FORMED METAL FRAMED AND GYPSUM WALL BOARD WALL AND CEILING SYSTEM. NOT EVERY ASPECT OF EVERY GYPSUM WALLBOARD DETAIL, ACCESSORY, TRANSITION OR TERMINATION DETAIL IS INDICATED IN THE CONTRACT DOCUMENTS.
- INSTALLED TYPICALLY THROUGHOUT THE PROJECT AS REFERENCED IN THE CONTRACT DOCUMENTS, AND IN THE ACOUSTICAL REPORTS. O. G.C. TO COORDINATE AND VERIFY ELEVATION OF

ACOUSTIC SEALANT WHERE INDICATED IN

DRAWINGS AND SPECS SHALL BE FIRE RATED AND

- TOP OF SLAB. GC TO PLACE CONCRETE STEP SUCH THAT FINISH SIDEWALK IS LEVEL W/T.O.S.
- ALL WINDOWS U.O.N. SHALL BE <u>DOUBLE PANE</u> INSULATING GLASS FILLED WITH ARGON GAS & HAVE A LOW-E COATING. SEE SHEET A10.40 FOR WINDOW SCHEDULE.
- BE CLEARLY VISIBLE FROM THE STREET OR ROAD SHALL BE A MINIMUM OF 4" HIGH AND WITH A MINIMUM STROKE WIDTH OF 1/2" WIDE, INSTALLED
- R. ALL EXTERIOR MATERIALS RETURN TO THE NEXT INSIDE CORNER U.O.N.

KEYN	IOTE LEGEND - MATERIAL ELEVATION
KEY VALUE	KEYNOTE TEXT
244	WHITE STUCCO, SMOOTH SAND FINISH
245	DARK GREY STUCCO,, SMOOTH SAND FINISH
246	PHENOLIC WOOD PANEL, PRODEMA OR SIM.
247	FIBER CEMENT
248	VERTICAL BOARD FORMED CONCRETE
249	BLACK ANODIZED ALUMINUM CANOPY
250	BLACK ANODIZED STOREFRONT
251	BUTT GLAZED STOREFRONT
253	PREFINISHED METAL PANEL

PLANNING 6.6.22 RESUBMITTA

ENTITLEMEN 5.5.22


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AND UNPUBLISHED WORK OF THE ARCHITECT AND MAY NOT BE DUPLICATED, USED OR DISCLOSED WITHOUT THE WRITTEN CONSENT OF THE ARCHITECT BLDG 1 (LOT 6) **ELEVATIONS**

SCALE: As indicated PROJ#. 2110 DRAWN BAUTHOR SHEET SIZE: 30 x 42

AP3.00



BUILDING 2 (LOT 5) - WEST ELEVATION 4

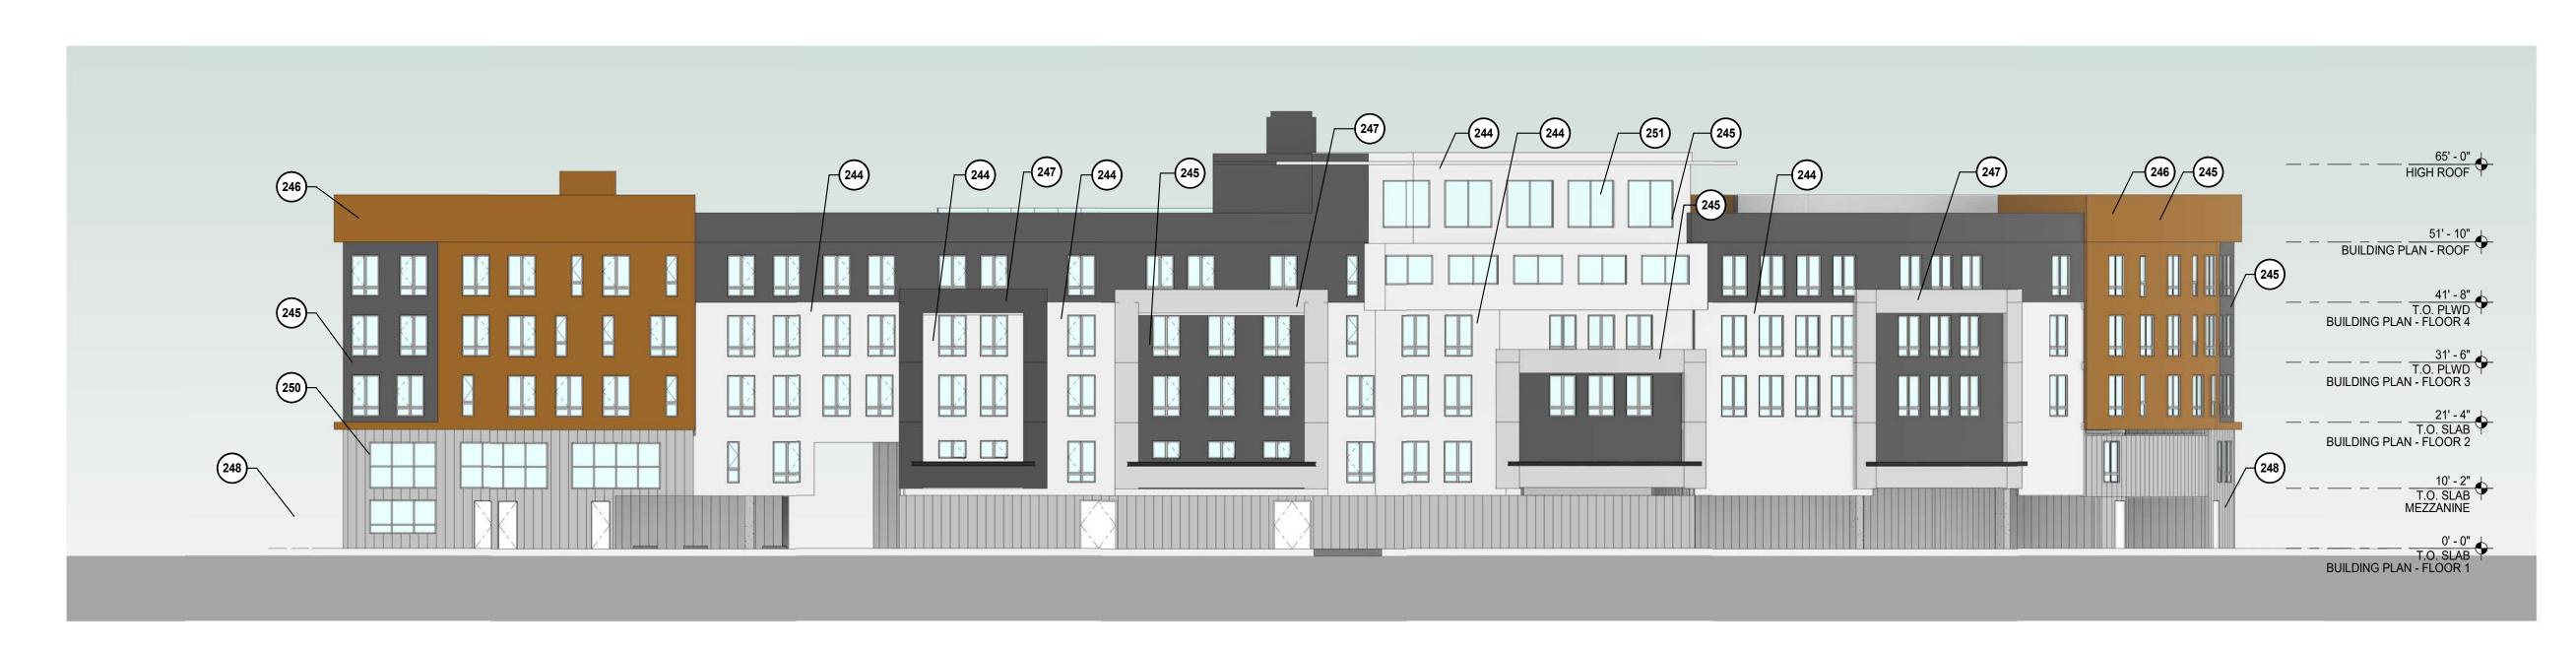

BUILDING 2 (LOT 5) - NORTH ELEVATION 3

1/16" = 1'-0"



BUILDING 2 (LOT 5) - SOUTH ELEVATION 21/16" = 1'-0"



BUILDING 2 (LOT 5) - EAST ELEVATION 1

GENERAL NOTES

- A. U.O.N. DIMENSIONS ARE TO FACE OF STUD OR FOUNDATION WALL, TYP. (FOR TYPE III OR TYPE V) FOR METAL-FRAMED BUILDINGS THE DIMENSIONS ARE TO THE FACE OF DRYWALL.
- B. SITE ELEVATION HEIGHT OF XXX.XX' = 0'-0" DATUM.
 C. SEE A0.2X FOR ACCESSIBILITY AND ADAPTABILITY
- REQUIREMENTS.

 SEE SHEET A10.X FOR WALL TYPE SCHEDULE AND TYPICAL ASSEMBLIES.
- D. SEE LANDSCAPE DRAWINGS FOR INFORMATION REGARDING THE GRADING OF ALL EXTERIOR AREAS.
 REFER TO 1/4" STAIR DRAWINGS FOR INFORMATION NOT SHOWN HERE.
- E. G.C. SHALL COORDINATE PLUMBING & MECHANICAL VENTS TO MINIMIZE ROOF PENETRATIONS AS
- PERMITTED BY CBC.

 F. G.C. TO COORD. AND INSTALL VENTING FOR ALL CONCEALED ROOF AREAS AND OTHER FRAMED
- G. ROOF SLOPES NOTED ARE MINIMUMS. ROOF SLOPES OF CRICKETS ARE SHOWN DIAGRAMMATICALLY ON ROOF PLANS AND MAY EXCEED 1/4"/1'-0",TO ACHIEVE PROPER ROOF DRAINAGE AS SHOWN. G.C. TO INCLUDE AND COORDINATE ROOF CRICKETS IN FIELD FOR PROPER DRAINAGE N ACCORDANCE WITH CODE AND ROOF MANUFACTURER'S WARRANTY.
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- J. CONCRETE CURBS SHALL BE INCLUDED AS INDICATED IN ARCHITECTURAL DRAWINGS IN ADDITION TO CURBS SHOWN ON STRUCTURAL DRAWINGS.
- K. THRESHOLDS MUST BE COMPLIANT AT ALL INTERIOR AND EXTERIOR DOORS, MAX 1/2" HEIGHT.
- L. PROVIDE BUILT-UP EPOXY GROUT LEVELING
 COMPOUND AT DECKS AS REQ'D TO PROVIDE
 LEVEL SURFACE AND 1/2" MAX THRESHOLD.
 FEATHER LEVELING COMPOUND INTO DECK

SURFACE AT MAX. 2% SLOPE.

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- N. ACOUSTIC SEALANT WHERE INDICATED IN DRAWINGS AND SPECS SHALL BE FIRE RATED AND INSTALLED TYPICALLY THROUGHOUT THE PROJECT AS REFERENCED IN THE CONTRACT DOCUMENTS, AND IN THE ACOUSTICAL REPORTS.
- O. G.C. TO COORDINATE AND VERIFY ELEVATION OF TOP OF SLAB. GC TO PLACE CONCRETE STEP SUCH THAT FINISH SIDEWALK IS LEVEL W/ T.O.S.
- P. ALL WINDOWS U.O.N. SHALL BE <u>DOUBLE PANE</u>
 INSULATING GLASS FILLED WITH ARGON GAS &
 HAVE A LOW-E COATING. SEE SHEET A10.40 FOR
 WINDOW SCHEDULE.
- Q. ADDRESS SIGNAGE ON BUILDING ELEVATION SHALL BE CLEARLY VISIBLE FROM THE STREET OR ROAD FRONTING THE PROPERTY. EACH CHARACTER SHALL BE A MINIMUM OF 4" HIGH AND WITH A MINIMUM STROKE WIDTH OF 1/2" WIDE, INSTALLED ON A CONTRASTING BACKGROUND PER CBC 501.2
- R. ALL EXTERIOR MATERIALS RETURN TO THE NEXT INSIDE CORNER U.O.N.

KEYN	NOTE LEGEND - MATERIAL ELEVATION
KEY VALUE	KEYNOTE TEXT
244	WHITE STUCCO, SMOOTH SAND FINISH
245	DARK GREY STUCCO,, SMOOTH SAND FINISH
246	PHENOLIC WOOD PANEL, PRODEMA OR SIM.
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249	BLACK ANODIZED ALUMINUM CANOPY
250	BLACK ANODIZED STOREFRONT
251	BUTT GLAZED STOREFRONT
253	PREFINISHED METAL PANEL

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BLDG 2 (LOT 5)

ELEVATIONS


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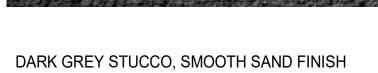
SCALE: As indicated

PROJ # 2110 DRAWN EAUTHOR

SHEET SIZE: 30 x 42

AP3.01



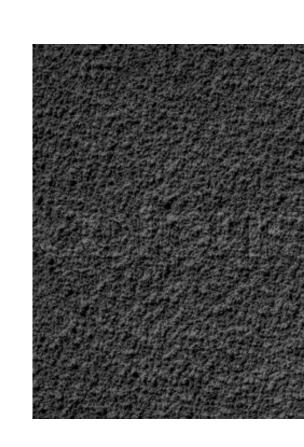



BLACK ANODIZED ALUMINUM CANOPY



METAL PANEL, DRY DESIGN OR SIM.

GLASS RAIL


BUTT GLAZZED STOREFRONT

PHENOLIC WOOD PANEL, PRODEMA OR SIM.



BLACK ANODIZED STOREFRONT

WHITE STUCCO, SMOOTH SAND FINISH

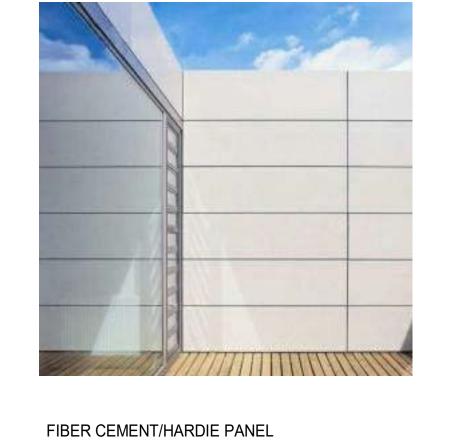



VERTICAL BOARD FORMED CONCRETE

SHEET SIZE: 30 x 42


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MATERIAL


1/16" = 1'-0"




BUILDING 2 SECTION EAST WEST 4 1/16" = 1'-0"

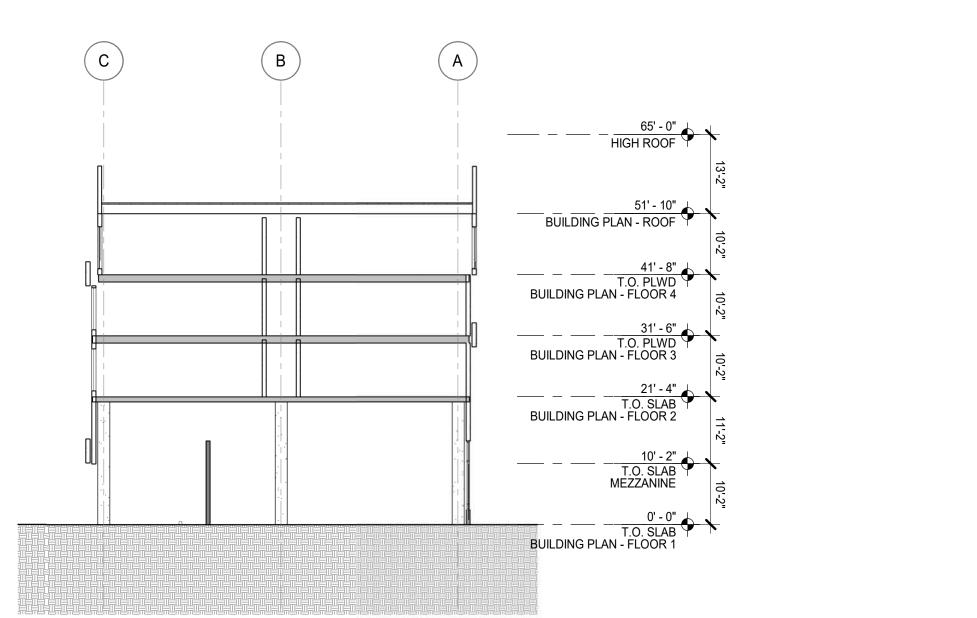


BUILDING 1 SECTION NORTH SOUTH 3

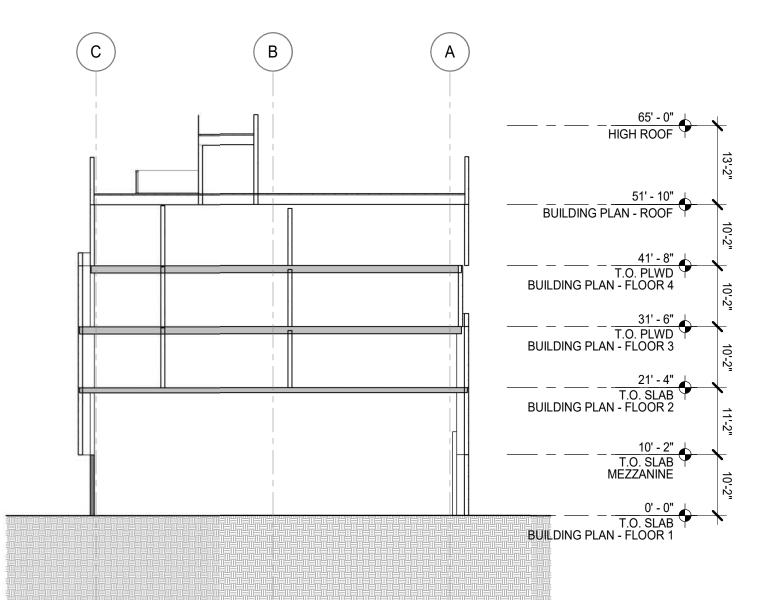

BUILDING 1 SECTION - NORTH SOUTH 2 1/16" = 1'-0"

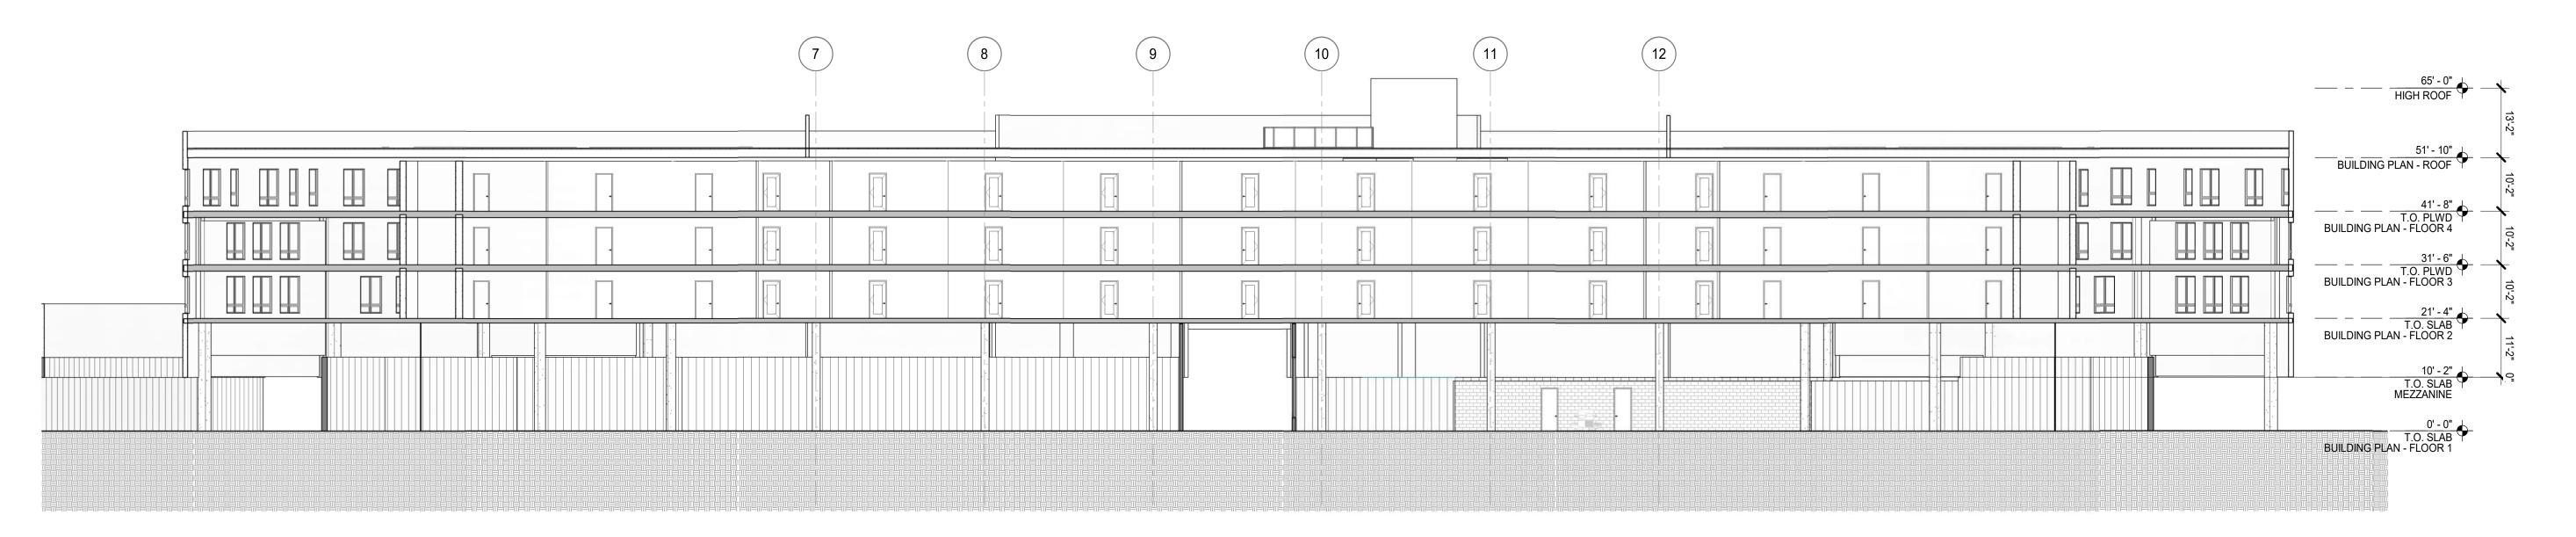

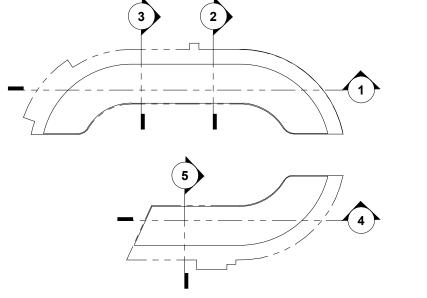

BUILDING 1 SECTION- EAST WEST 1/16" = 1'-0"

GENERAL NOTES

- A. DIMENSIONS ARE TO FACE OF STUD, CONCRETE OR FOUNDATION WALL, TYP. U.O.N.
- B. SITE ELEVATION HEIGHT OF 115.5' = 0'-0" DATUM. SEE A0.2 FOR ACCESSIBILITY AND ADAPTABILITY REQUIREMENTS.
- C. SEE SHEET A10.0 FOR WALL TYPE SCHEDULE AND TYPICAL ASSEMBLIES.
- D. SEE LANDSCAPE DRAWINGS FOR INFORMATION REGARDING THE GRADING OF ALL EXTERIOR AREAS. REFER TO 1/4" STAIR DRAWINGS FOR INFORMATION NOT
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- H. G.C. SHALL PROVIDE SAFETY GLAZING IN ALL LOCATIONS REQUIRED BY CBC SECTION 2406 AND AS REQUIRED BY
- I. G.C. SHALL INCLUDE GSM FLASHING AT ALL MATERIAL TRANSITIONS. ALL GSM FLASHING SHALL BE GALVANIZED OR BONDERIZED AND PAINTED OR RECEIVE COATINGS TO MATCH SURROUNDING MATERIALS.
- J. CONCRETE CURBS SHALL BE INCLUDED WHETHER INDICATED OR NOT AT ALL LOCATIONS FOR EXT. WATER
- K. THRESHOLDS MUST BE ADA COMPLIANT AT ALL INTERIOR AND EXTERIOR DOORS.
- L. CONCRETE LEVELING COMPOUND AT DECKS, SHOWERS OR OTHERWISE TO PROVIDE FLUSH LEVEL AND ADA COMPLIANT TRANSITIONS AT DOOR THRESHOLDS TO DECKS AND ADA SHOWERS SHALL INCLUDE, WETHER SPECIFIED OR NOT, ANY AND ALL ACCESSORIES, COMPONENTS OR OTHER REQUIREMENTS TO PROVIDE A FULLY WARRANTED SYSTEM. MEANING THE G.C. SHALL RETAIN SUBCONTRACTORS THAT ARE SPECIALISTS IN THEIR FIELD AND ARE EXPECTED TO ADD TO THE GMP THESE REQUIREMENTS AND COSTS.
- M. THE G.C. SHALL INCLUDE IN THE GMP THE LABOR AND MATERIALS TO PROVIDE A COMPLETE COLD FORMED METAL FRAMED AND GYPSUM WALL BOARD WALL AND CEILING SYSTEM. NOT EVERY ASPECT OF EVERY GYPSUM WALLBOARD DETAIL, ACCESSORY, TRANSITION OR TERMINATION DETAIL IS INDICATED IN THE CONTRACT DOCUMENTS.
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- Q. ADDRESS SIGNAGE ON BUILDING ELEVATION ARE TO BE CLEARLY VISIBLE FROM THE STREET OR ROAD FRONTING THE PROPERTY. EACH CHARACTER SHALL BE A MINIMUM OF 4" HIGH AND A MINIMUM OF 1/2" WIDE, INSTALLED ON A CONTRASTING BACKGROUND PER CBC 501.2

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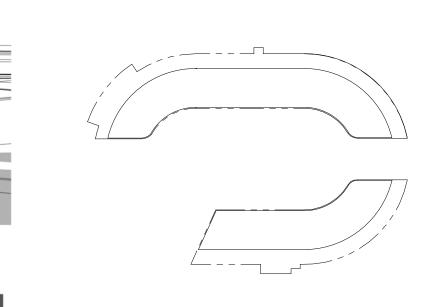
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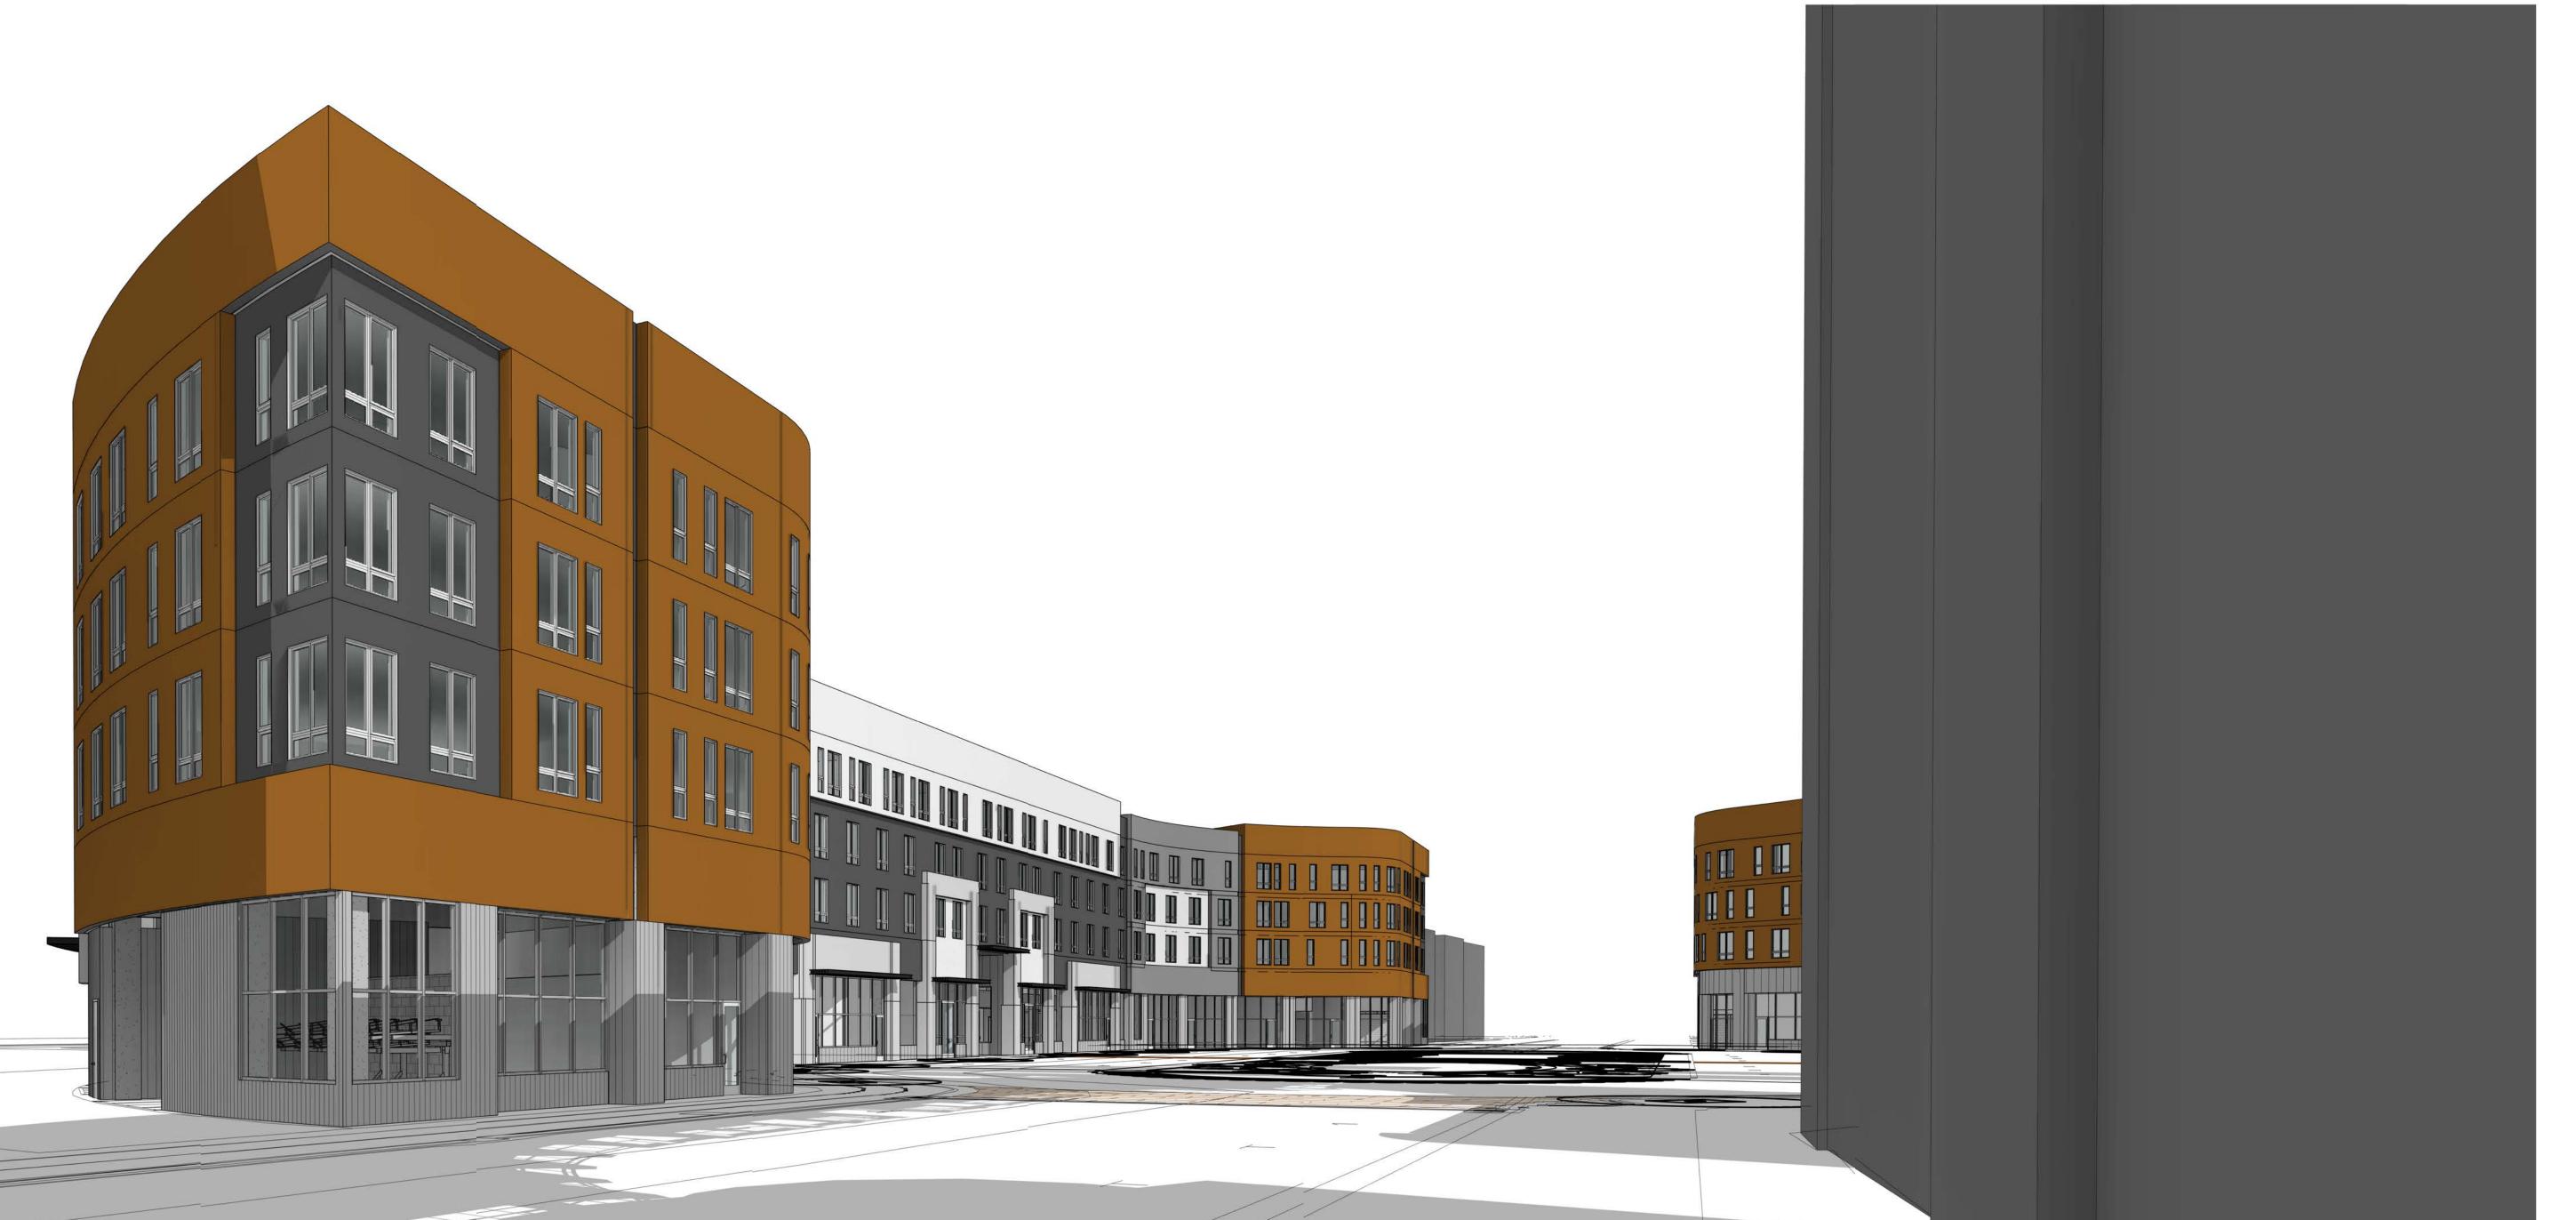
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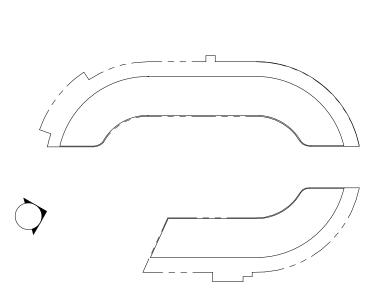
SECTIONS

scale: As indicated PROJ#. 2110 DRAWN EAUTHOR SHEET SIZE: 30 x 42









PERSPECTIVE BUILDING 1 (LOT 6 & BUIDLING 2 (LOT 2) - NORTH SITE ENTRY 1

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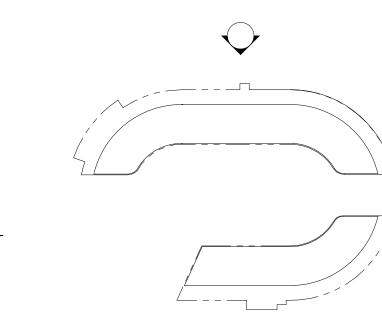
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SHEET SIZE: 30 x 42

AP3.30





PERSPECTIVE - BUILDING 1 (LOT 6) ENTRY EAST 2



PERSPECTIVE - BUILDING 1 (LOT 6) ENTRY WEST 1

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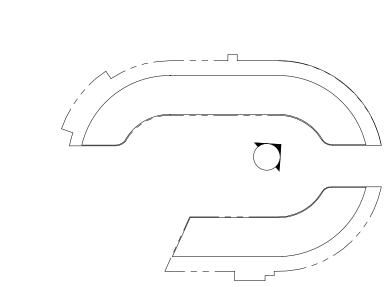
PERSPECTIVE
RENDERINGS

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SHEET SIZE: 30 x 42


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PERSPECTIVE - BUILDING 2 (LOT 5) ENTRY WEST 1

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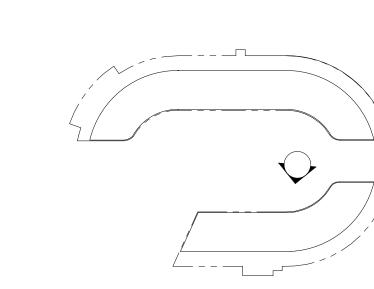
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PERSPECTIVE **RENDERINGS**


SHEET SIZE: 30 x 42

AP3.32



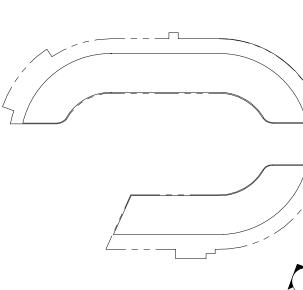



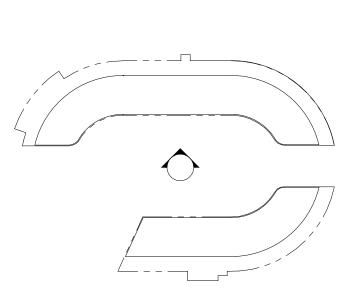

PERSPECTIVE - BUILDING 2 (LOT 5) COURTYARD 1

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PERSPECTIVE **RENDERINGS**

SHEET SIZE: 30 x 42

AP3.33

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PERSPECTIVE RENDERINGS


SHEET TITLE:
SCALE:

PROJ#. 2110 DRAWN EAUT

AP3.34

PERSPECTIVE - BUILDING 2 (LOT 5) EAST ENTRY 1



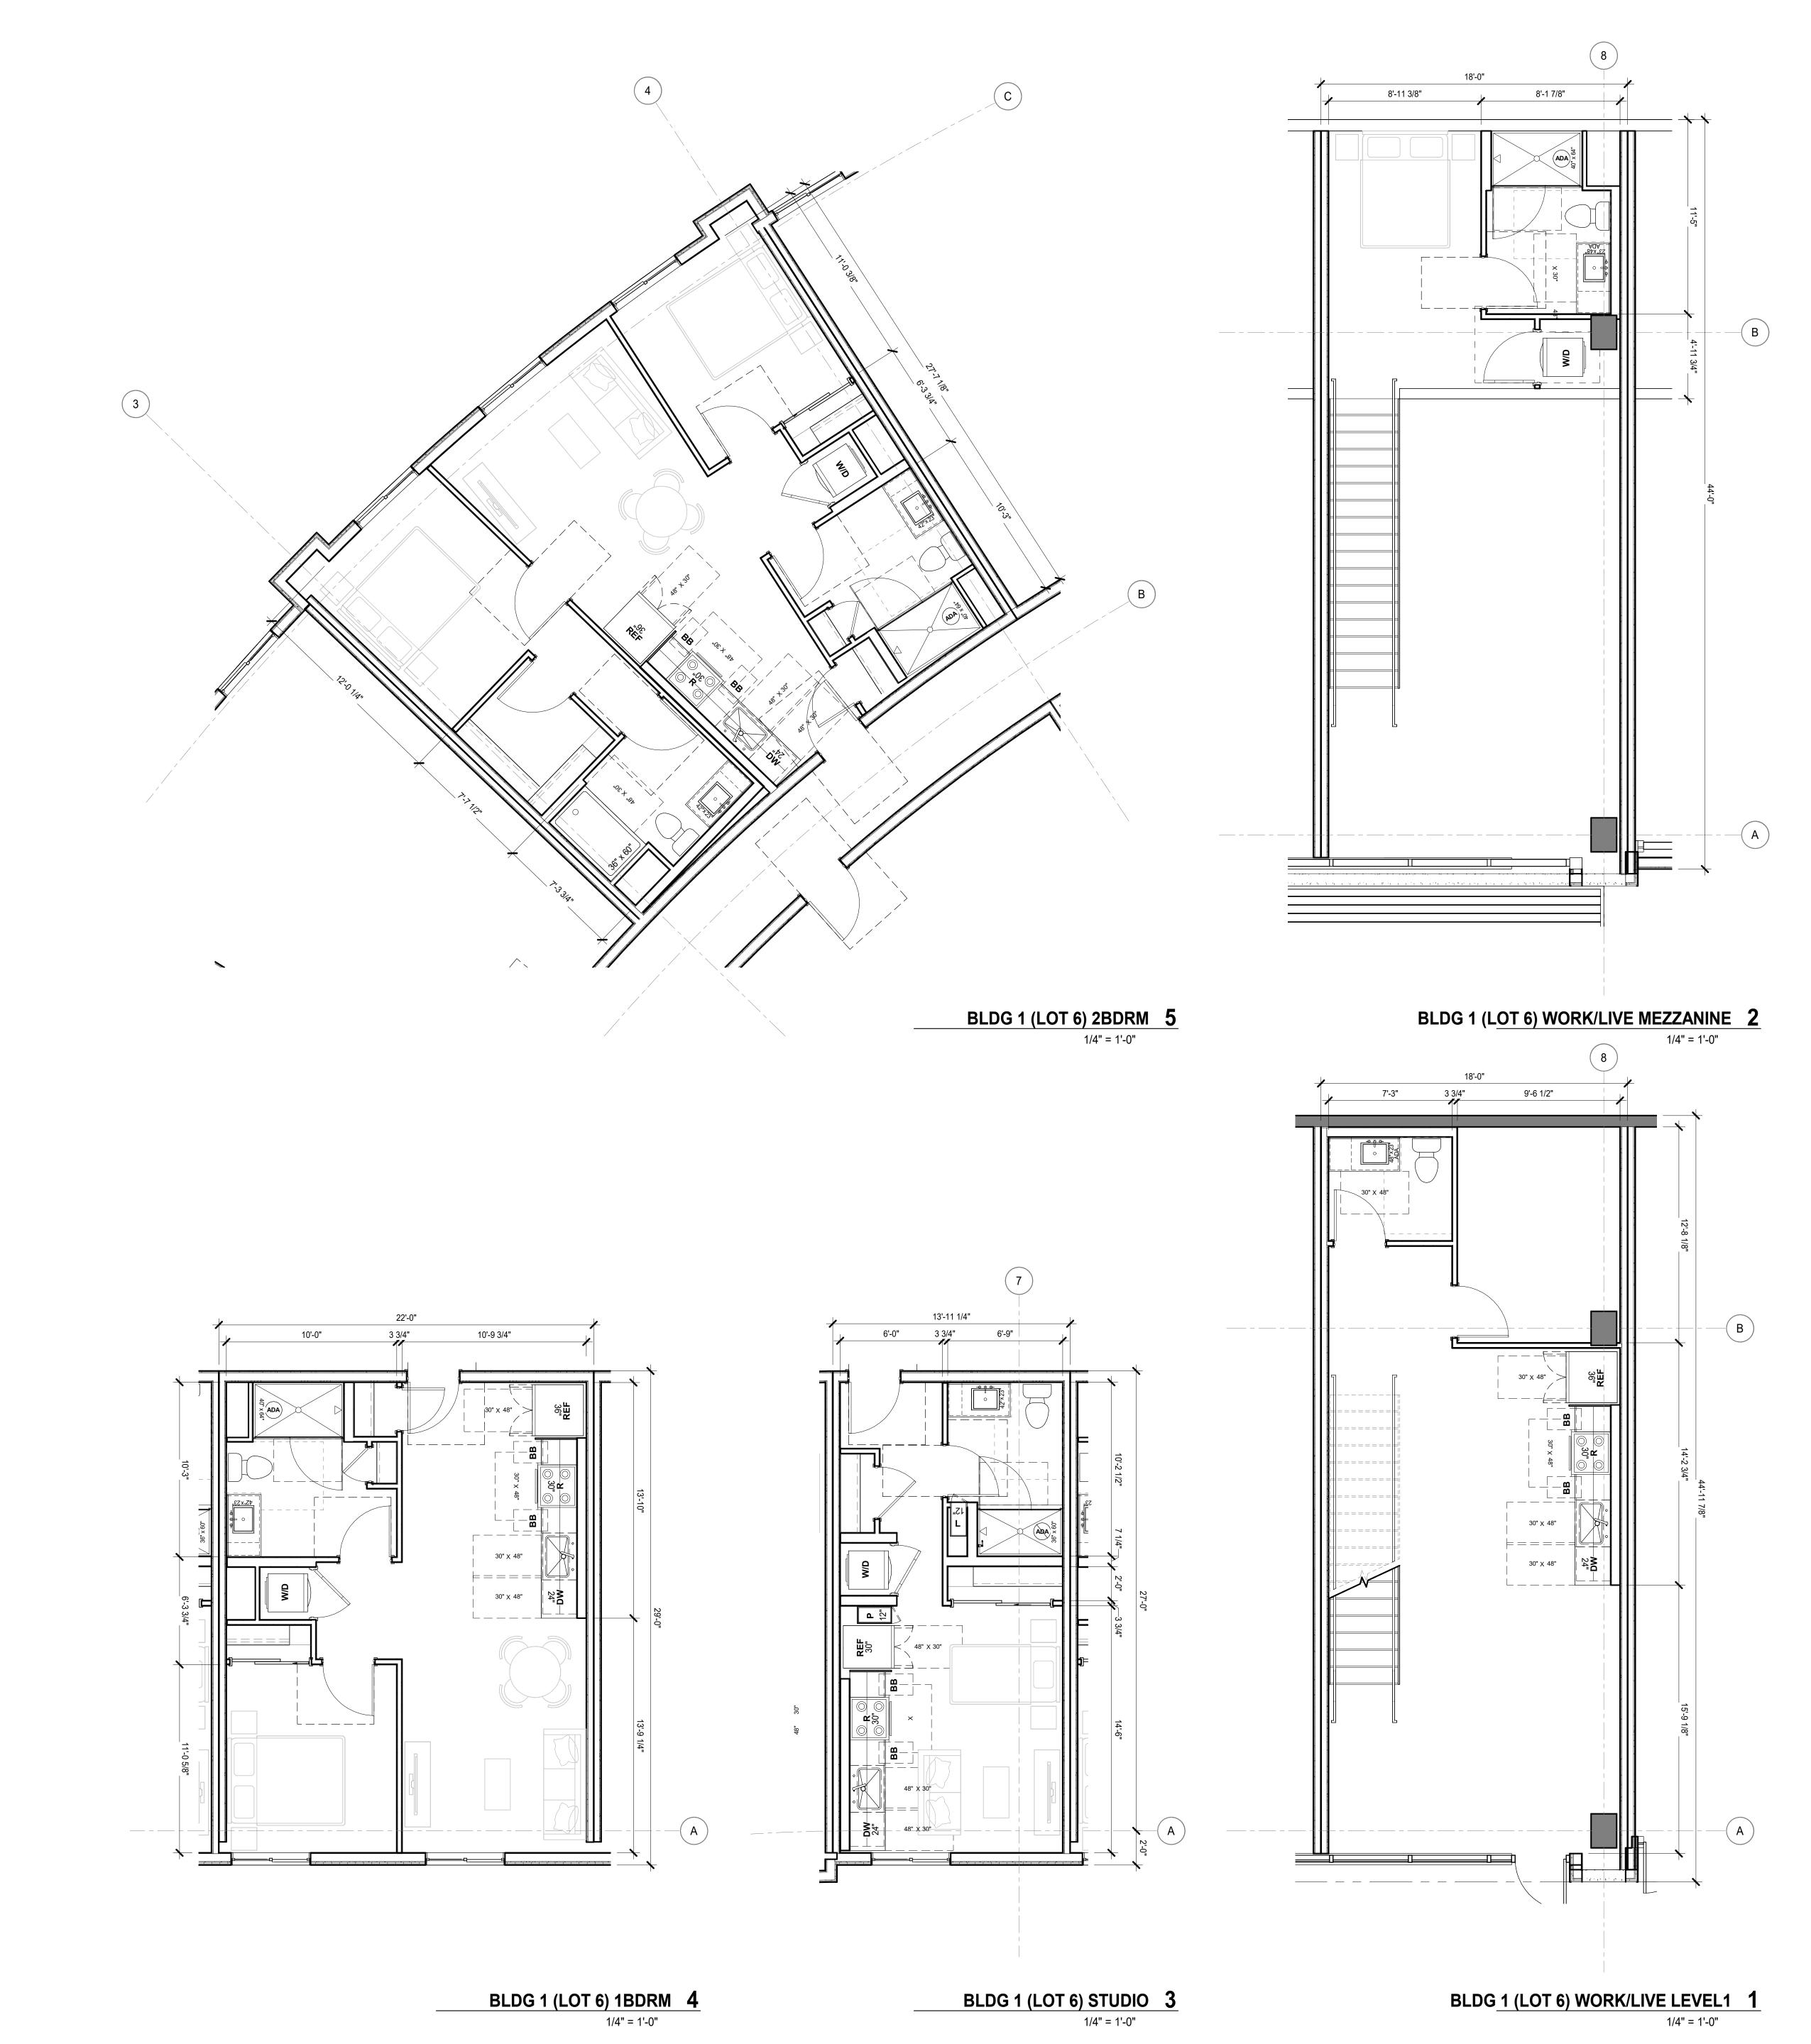

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SCALE: 1/4" = 1'-0"

PROJ #. 2110 DRAWN BAUTHOR

SHEET SIZE: 30 X 42

AP4.01



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PLANNING 6.6.22 RESUBMITTA L 1

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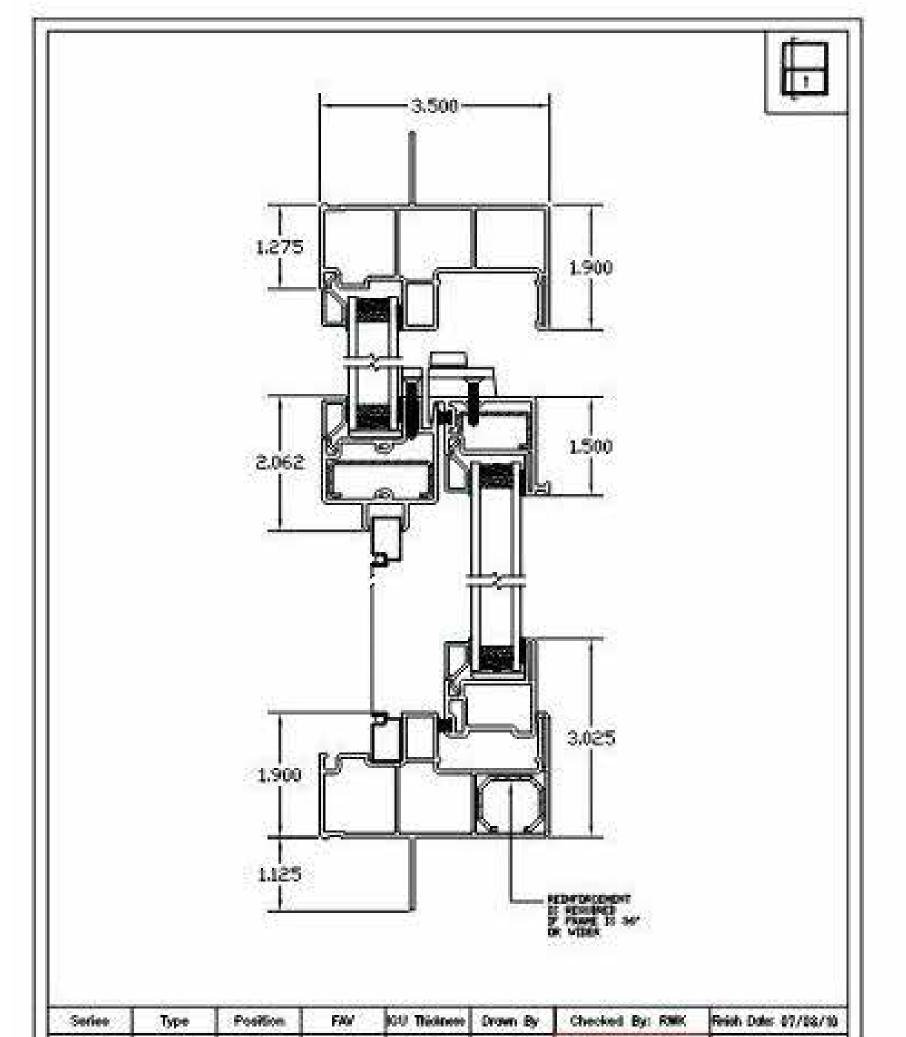
BLDG 2 (LOT 5) UNITS PLANS


SCALE: 1/4" = 1'-0"


PROJ #. 2110 DRAWN EAUTHOR


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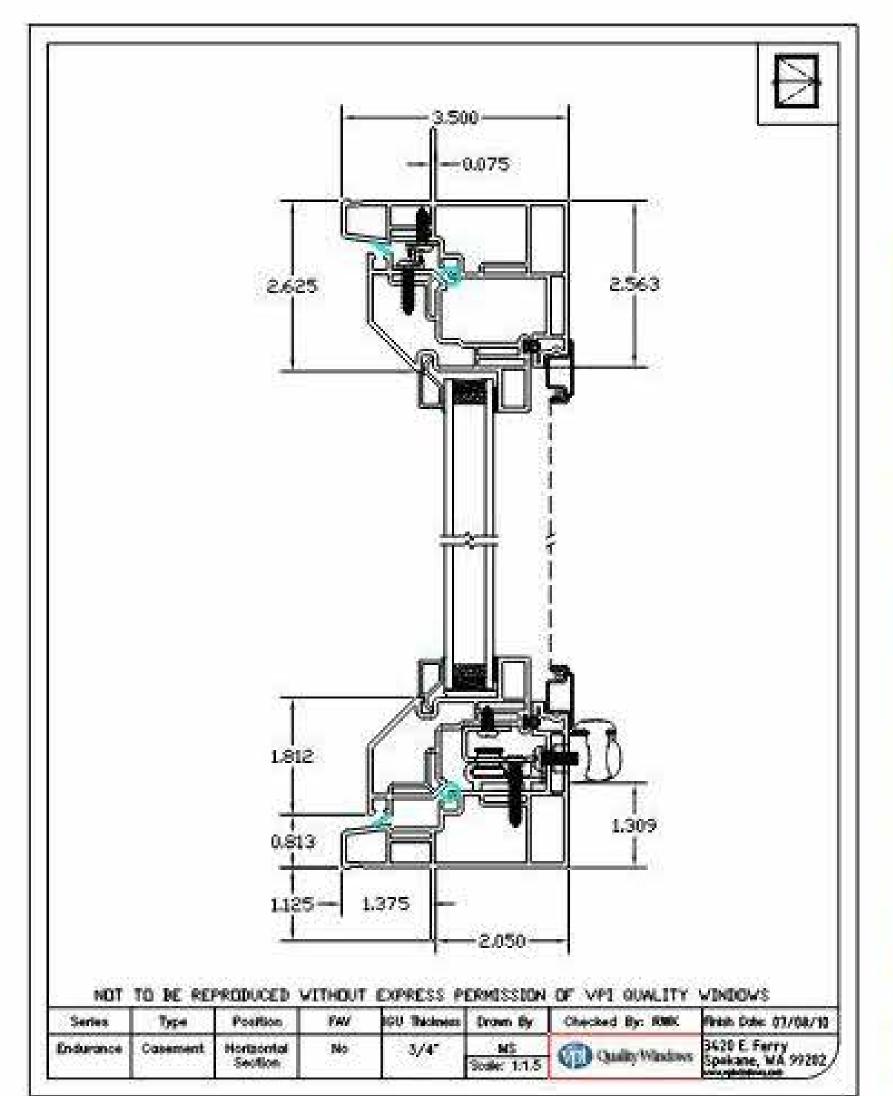
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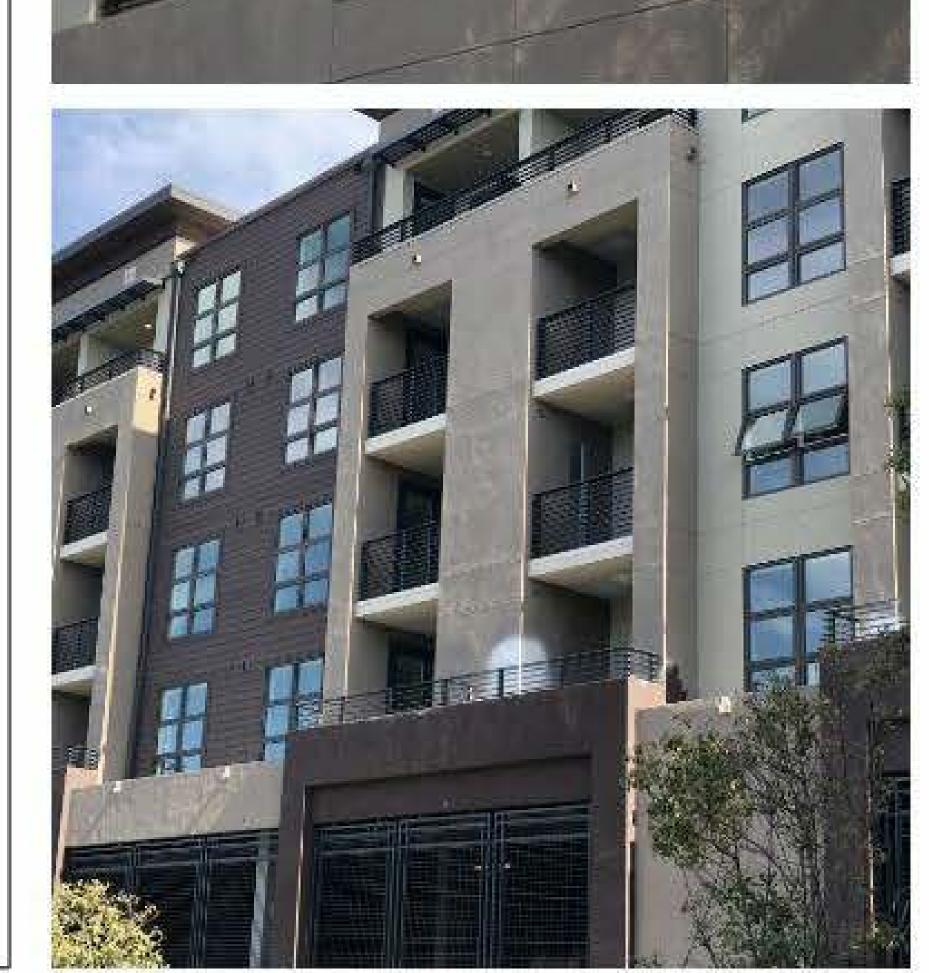







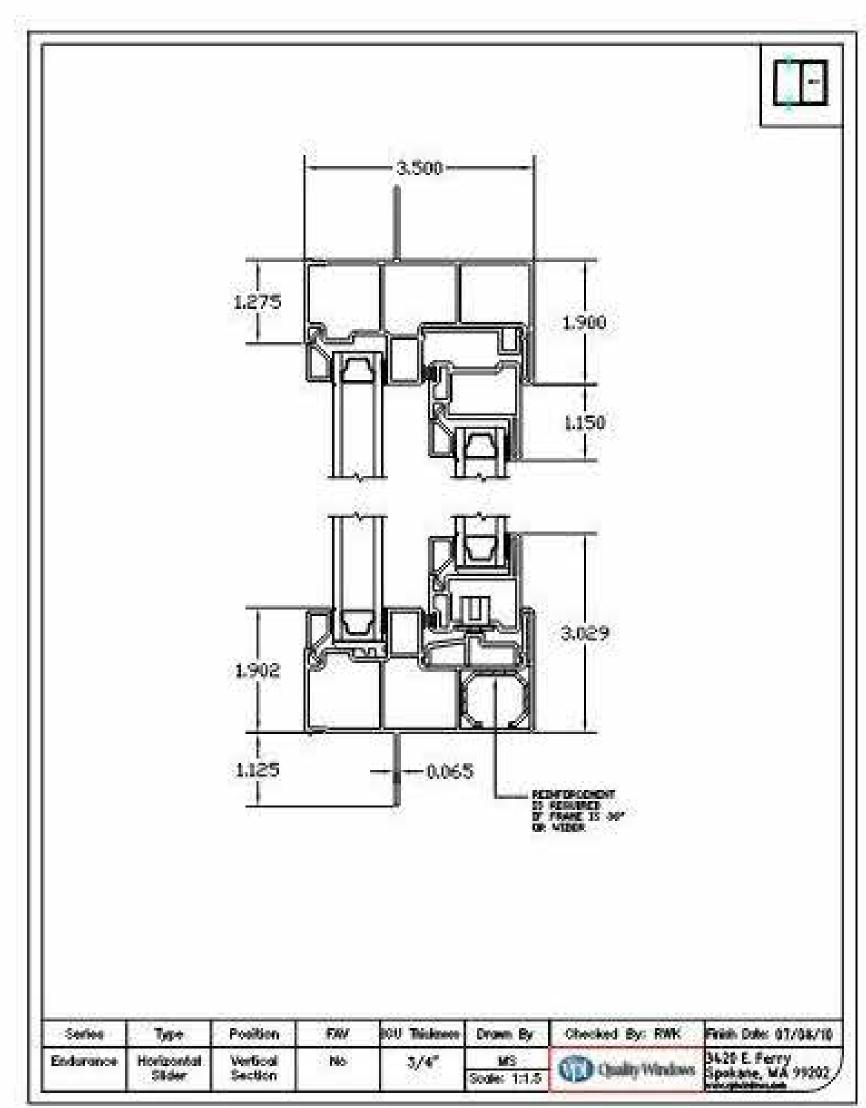

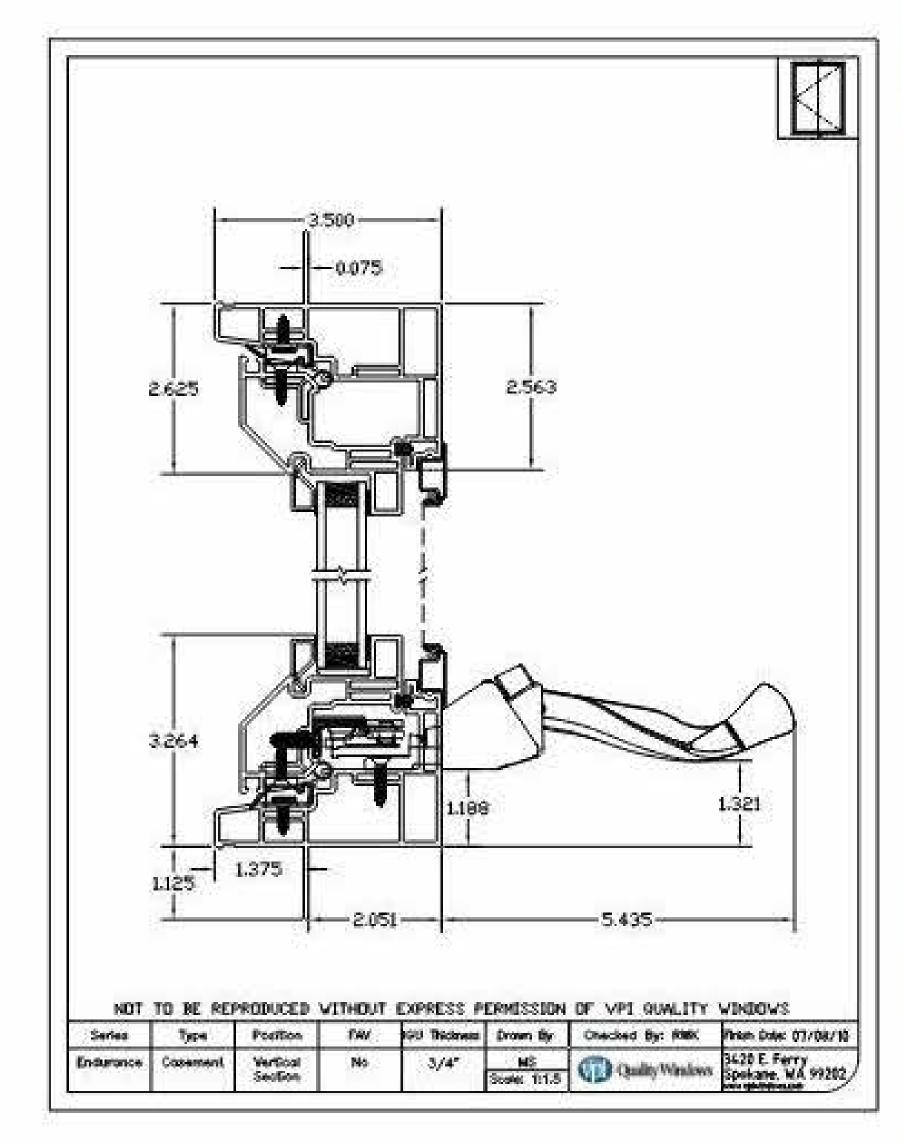

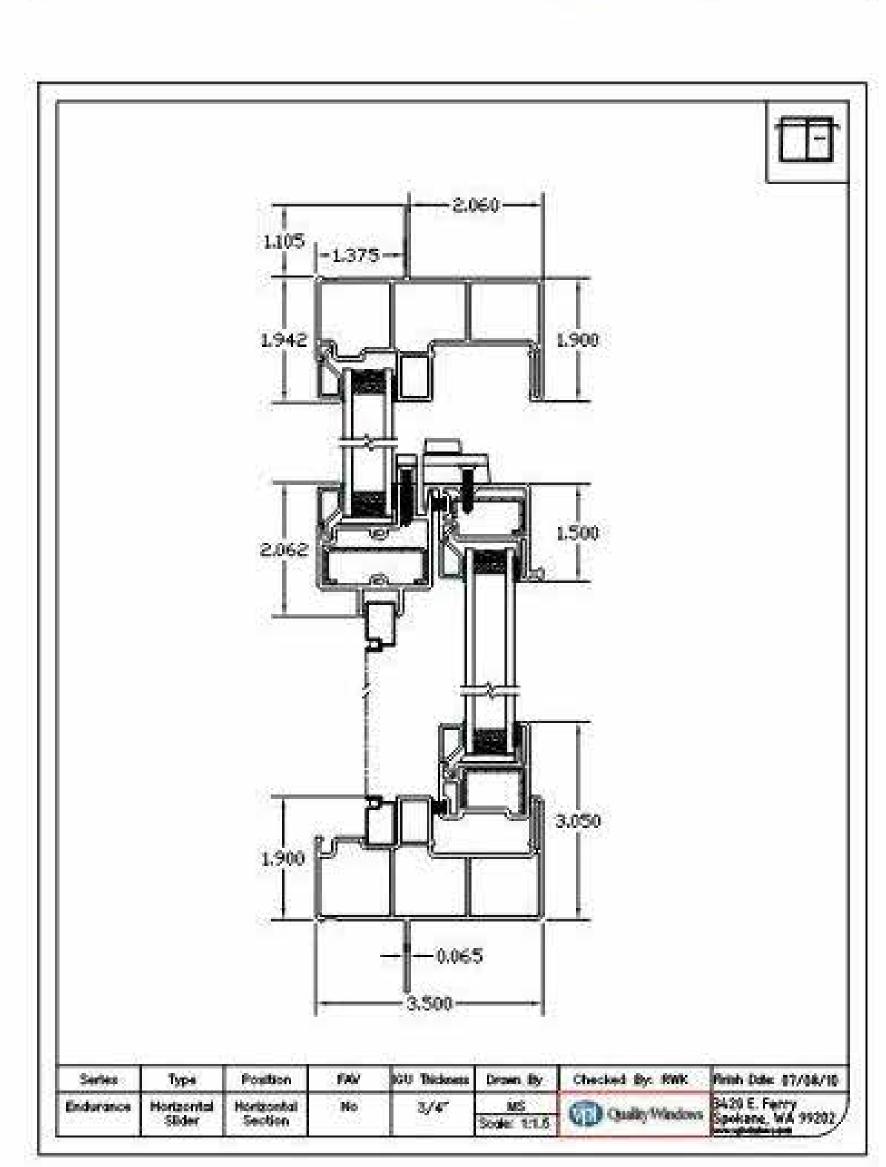

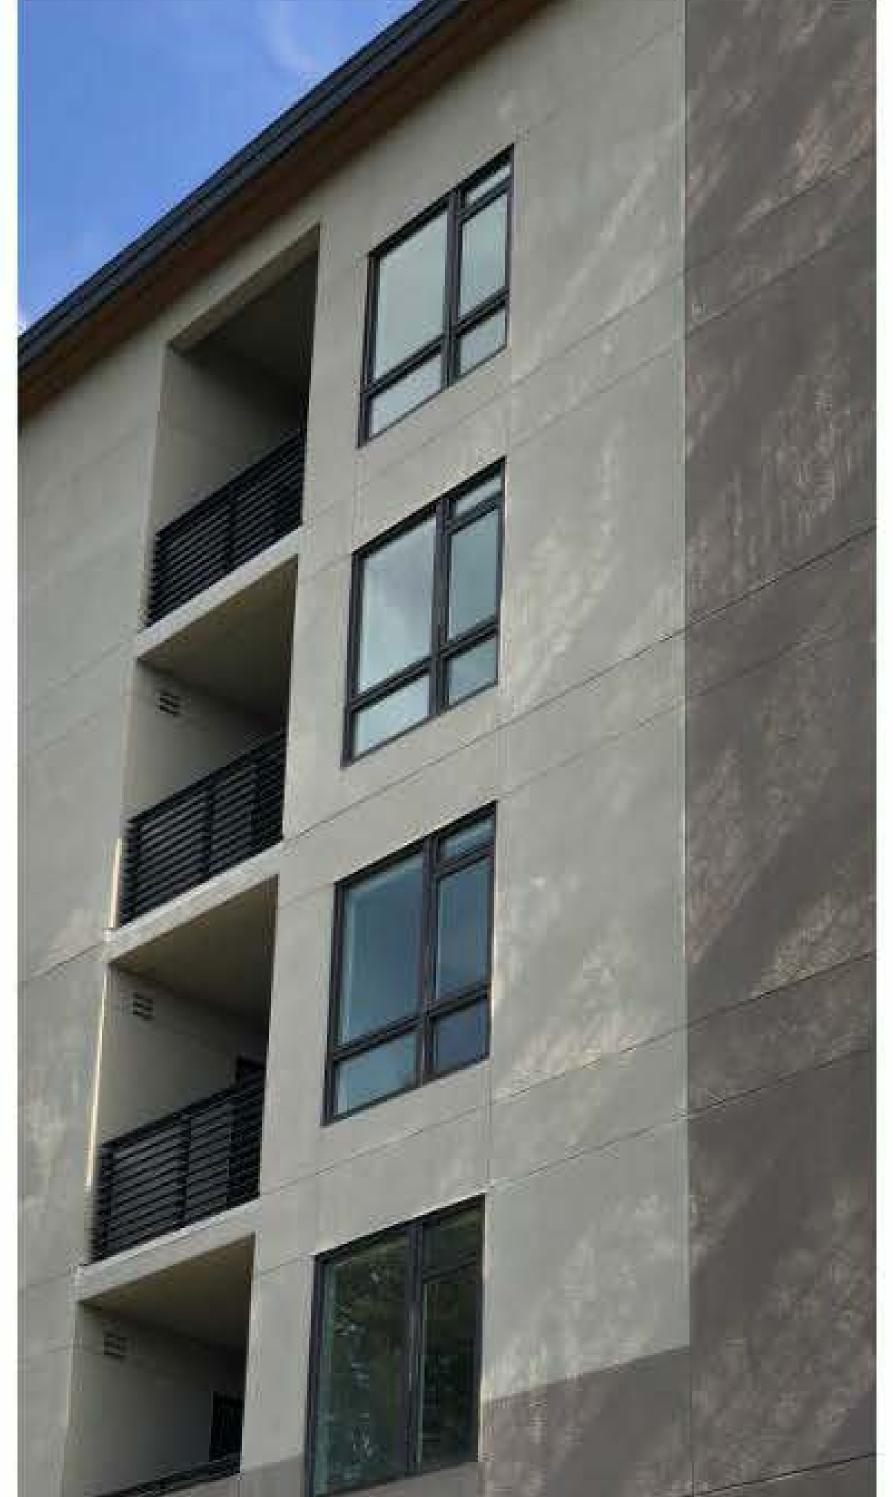

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EXT. DETAILS &

MATERIALS

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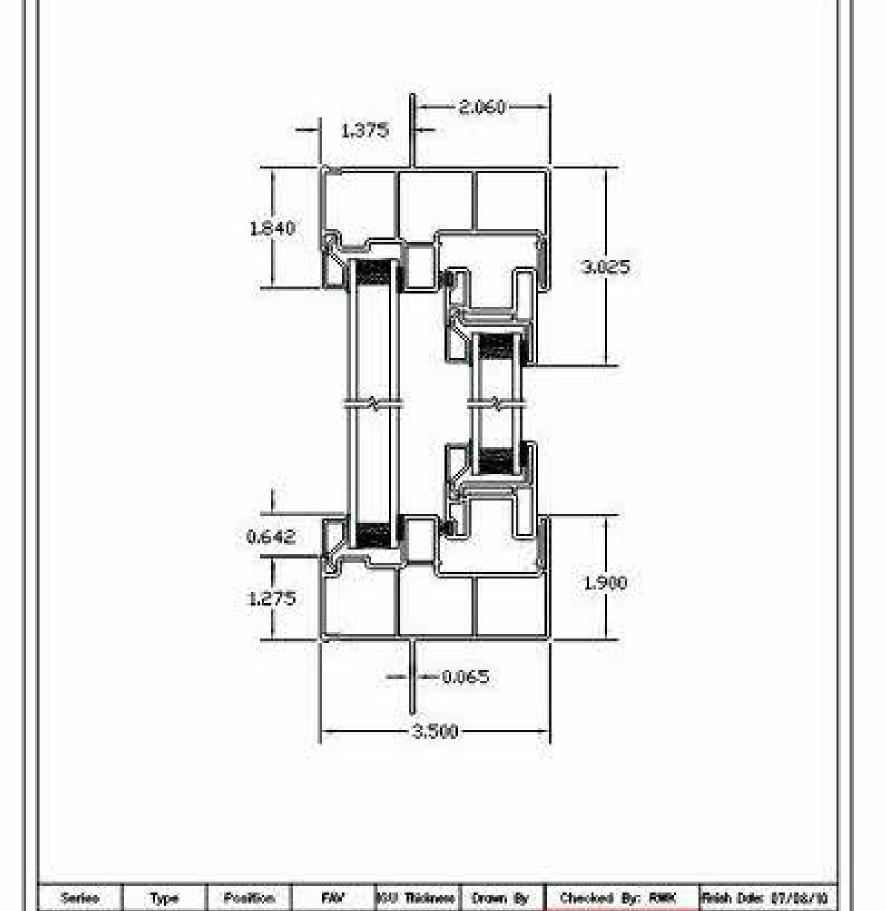
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SHEET TITLE:

SCALE:

PROJ #. 2110 DRAWN EAUTHOR

SHEET SIZE: 30 X 42



VPI WINDOWS OR SIMILAR - SINGLE HUNG 13


Single Hung

Horizontal Section

VPI WINDOWS OR SIMILAR - HORIZONTAL SLIDER

VPI WINDOWS - CASEMENT 5

VPI WINDOWS OR SIMILAR - IMAGES

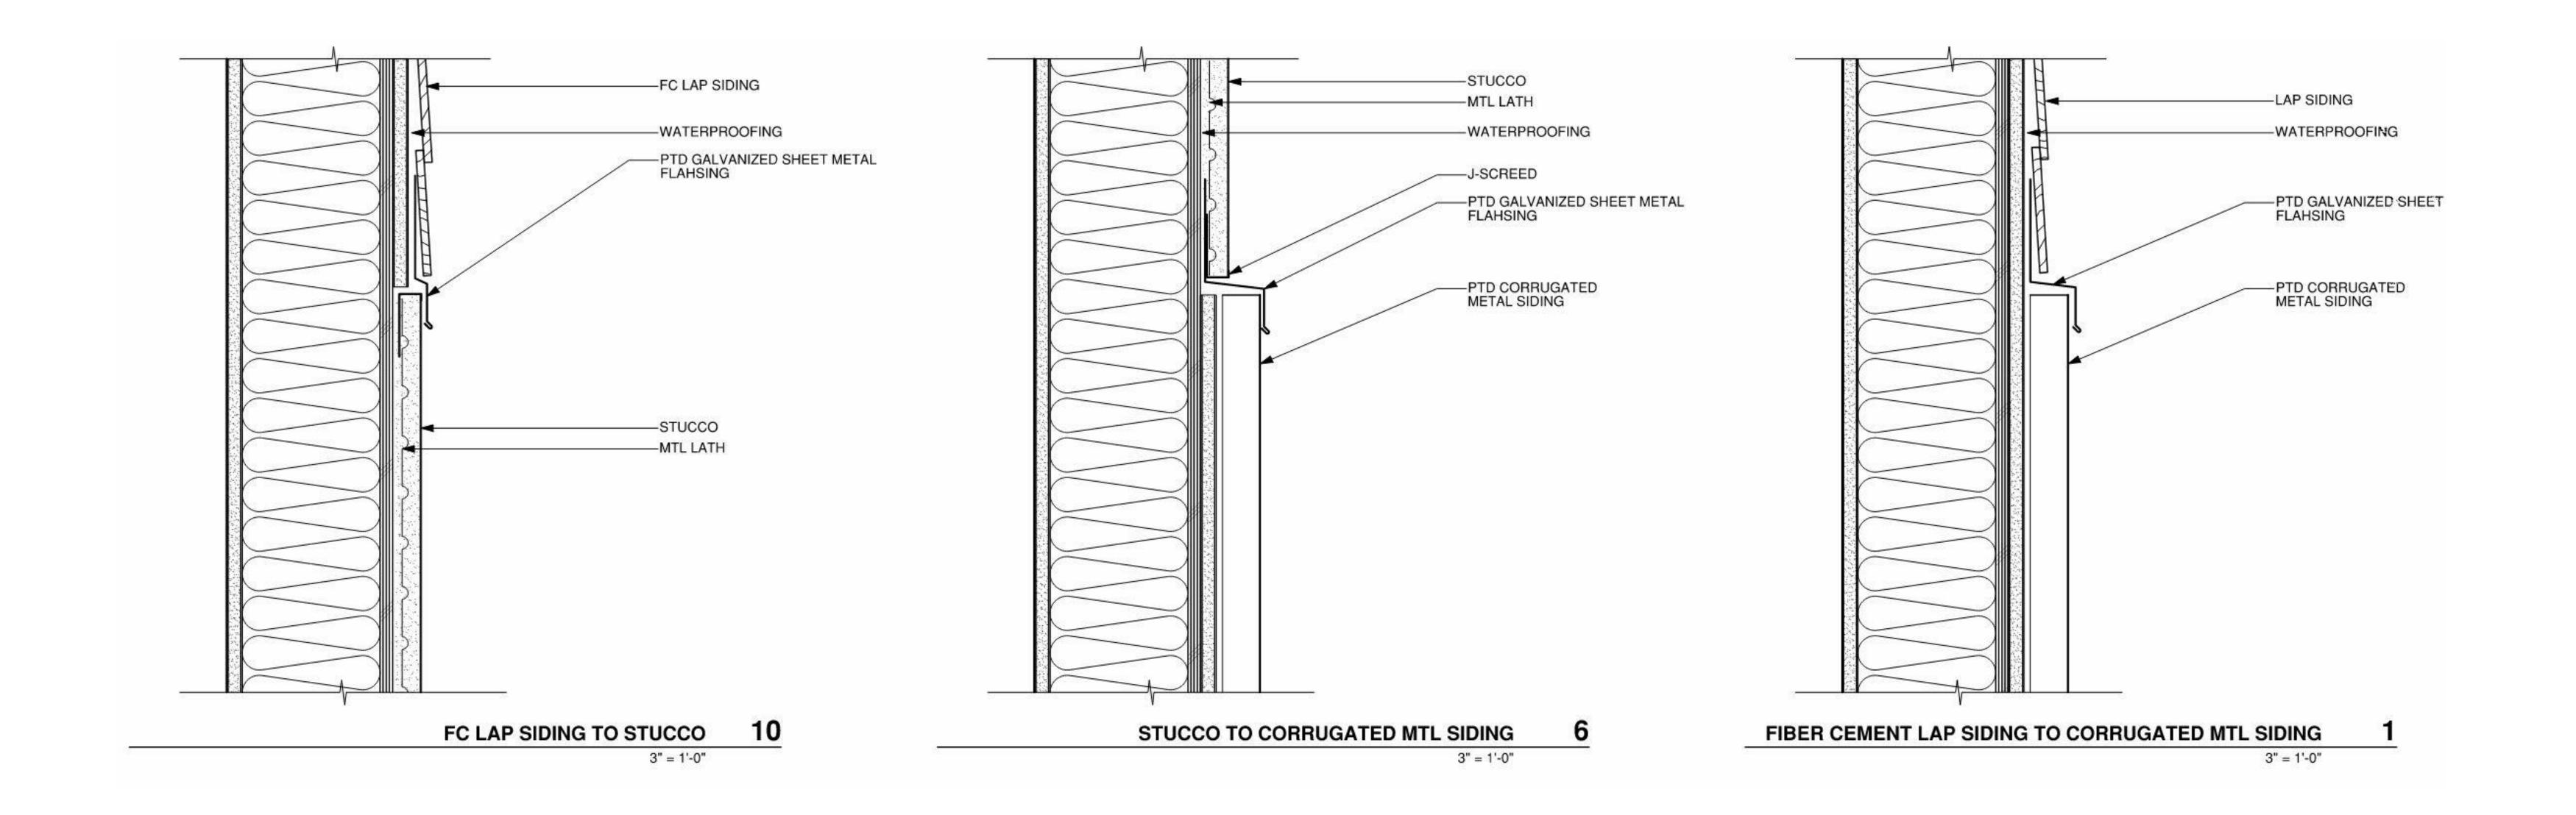

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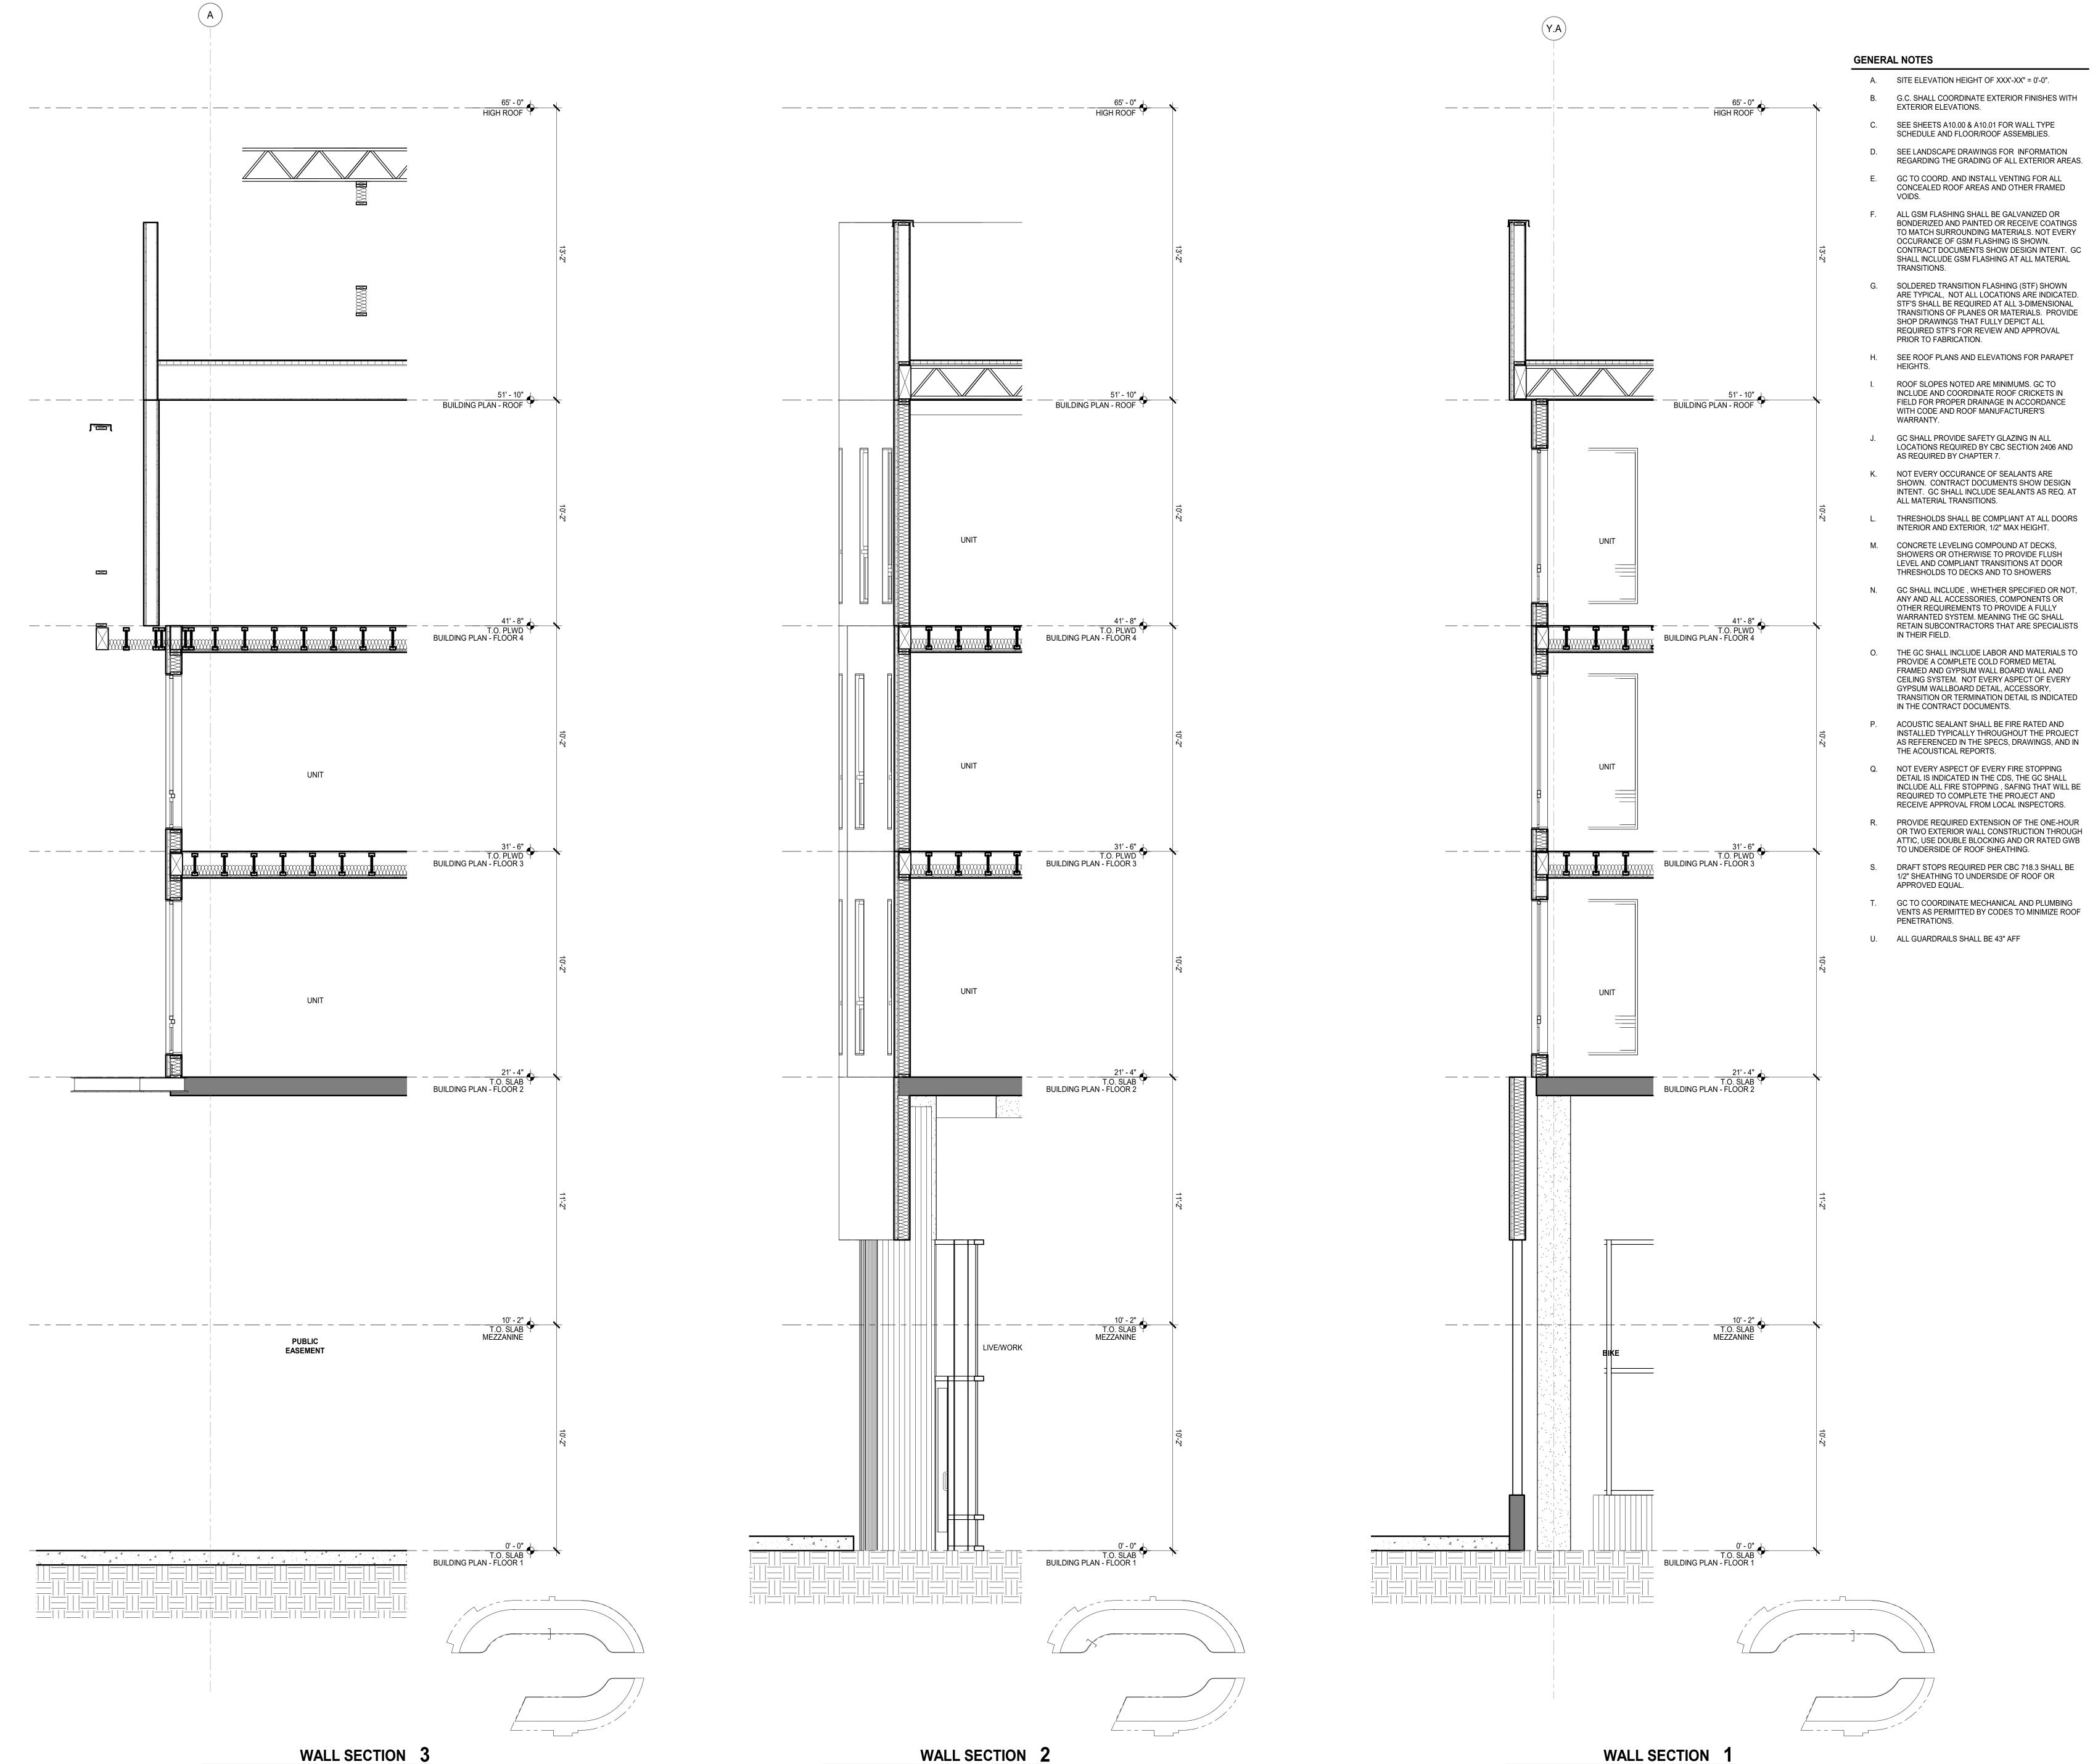
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EXT. DETAILS & MATERIALS

SCALE:

PROJ #. 2110 DRAWN EAUTH

SHEET SIZE: 30 X 42



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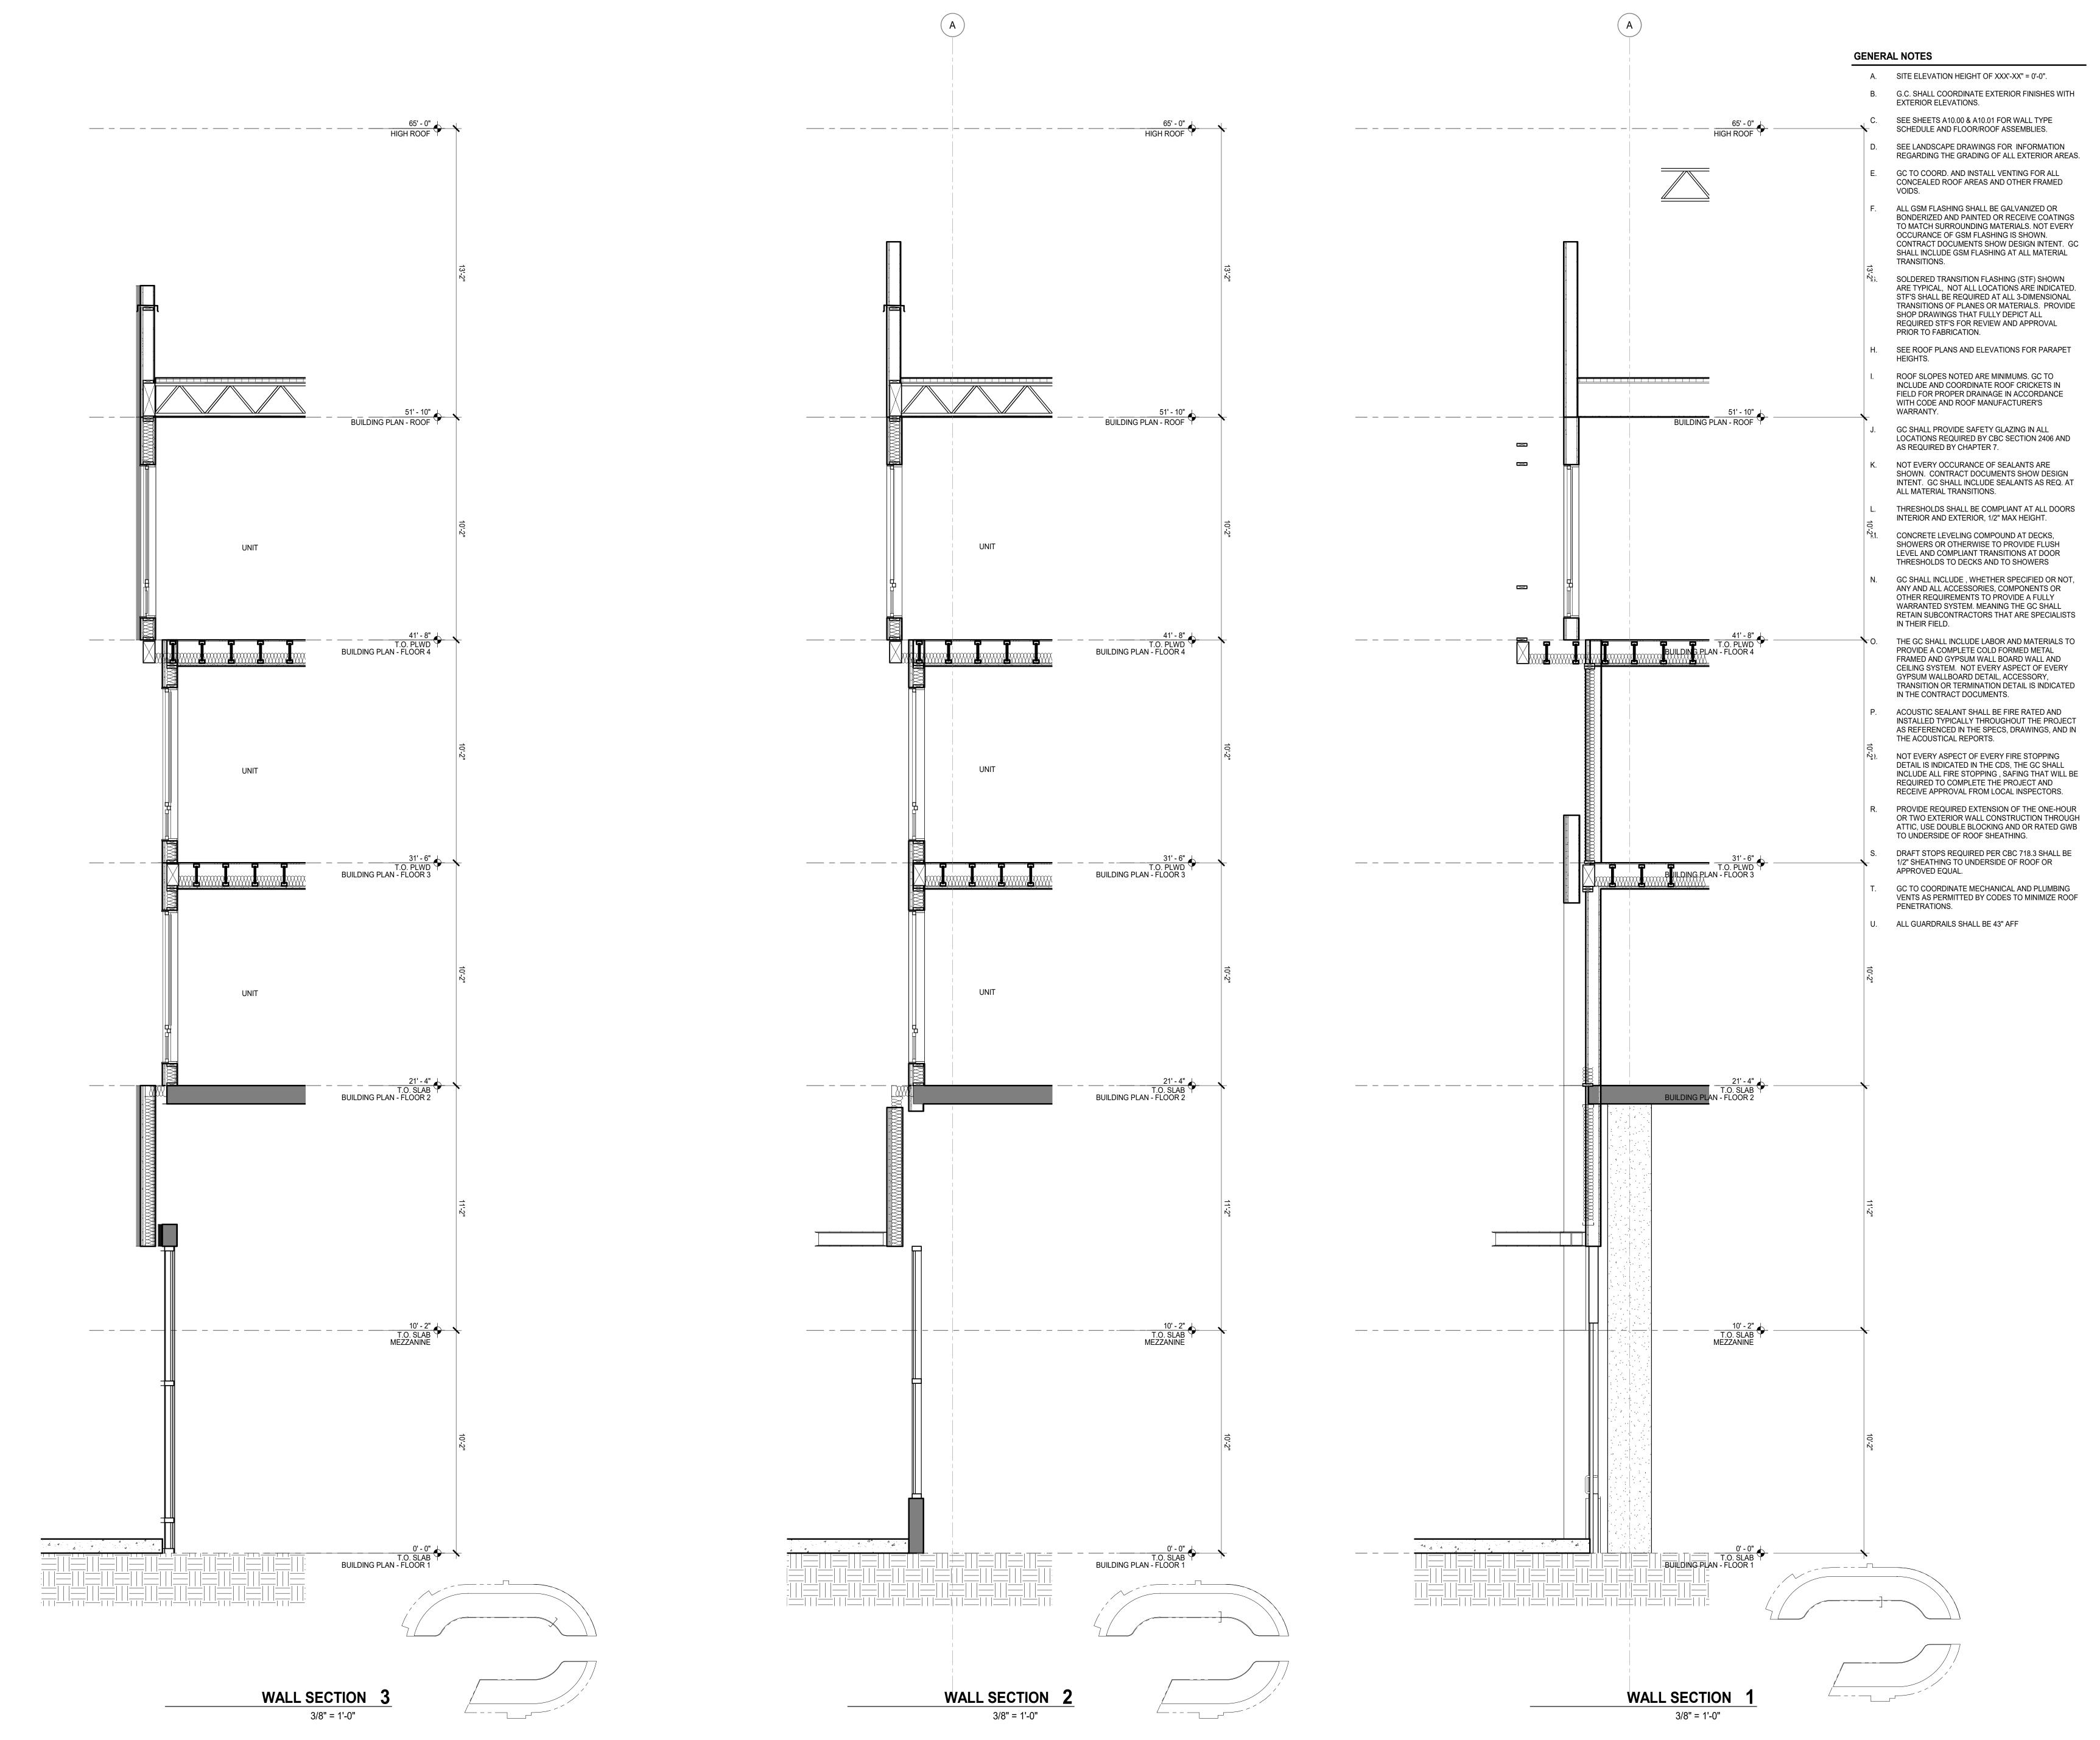
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WALL SECTION

SCALE: As indicated
PROJ #. 2110 DRAWN EAUTH
SHEET SIZE: 30 x 42

AP7.00



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WALL SECTION

scale: As indicated SHEET SIZE: 30 x 42